

ELECTRICAL SYMBOL LEGEND

(REFER TO DRAWINGS AND SPECIFICATIONS FOR FURTHER REQUIREMENTS)

GENERAL

1 KEYNOTE
 A-1,3 CIRCUIT TAG, PANEL AND CIRCUIT DESIGNATION AS INDICATED; E.G. PANEL 'A', CIRCUIT #1.3

WIRE, CONDUIT, AND RACEWAY

ABOVE-SLAB CONDUIT & WIRE/CABLING
 BELOW-SLAB CONDUIT & WIRE/CABLING; 3/4" MINIMUM CONDUIT SIZE UON
 HOMERUN TO PANEL; TICK MARKS INDICATED NUMBER OF WIRES

DISTRIBUTION

PANELBOARD, SWITCHBOARD, OR OTHER DISTRIBUTION EQUIPMENT AS NOTED; INSTALL WITH SUFFICIENT WORKING SPACE AND CLEARANCES TO MEET ALL REQUIREMENTS OF NEC SECTION 110.26.

GEN-ANNC GENERATOR REMOTE ANNUNCIATOR PANEL; PROVIDE CONDUIT/CABLING TO GENERATOR AS REQUIRED PER THE MANUFACTURER'S SPECIFICATIONS.

EQUIPMENT CONNECTIONS
 (PROVIDE CONDUIT AND WIRE PER THE PANEL SCHEDULE)

FUSED SAFETY DISCONNECT SWITCH; LOCATE WITHIN SIGHT OF THE EQUIPMENT SERVED WITH 36" MINIMUM CLEAR WORKING SPACE IN FRONT OF THE SWITCH; DO NOT MOUNT DIRECTLY TO EQUIPMENT
 JUNCTION BOX
 JUNCTION BOX FOR MOTORIZED DAMPER
 MOTOR RATED SWITCH WITH THERMAL OVERLOAD; LOCATE WITHIN SIGHT OF THE EQUIPMENT SERVED; DO NOT MOUNT DIRECTLY TO EQUIPMENT; WHEN LOCATED ABOVE CEILING, MOUNT TO STRUCTURAL MEMBER NEARBY
 ELECTRICAL MOTOR, HORSEPOWER AS NOTED

POWER DEVICES
 (PROVIDE CONDUIT AND WIRE PER THE PANEL SCHEDULE)

DUPLEX RECEPTACLE
 DUPLEX RECEPTACLE MOUNTED FLUSH TO CEILING OR MOUNTED TO STRUCTURE IN AREAS WITH NO CEILING; SUBSCRIPT (WHEN USED): CR - CORD REEL
 ABOVE-COUNTER DUPLEX RECEPTACLE; MOUNT AT 6" ABOVE COUNTER OR BACKSPASH OR 44" (WHICHEVER IS LOWER)
 GFOI DUPLEX RECEPTACLE
 ABOVE-COUNTER GFOI DUPLEX RECEPTACLE; MOUNT AT 6" ABOVE COUNTER OR BACKSPASH OR 44" (WHICHEVER IS LOWER)
 QUADRUPLEX RECEPTACLE
 ABOVE-COUNTER QUADRUPLEX RECEPTACLE; MOUNT AT 6" ABOVE COUNTER OR BACKSPASH OR 44" (WHICHEVER IS LOWER)
 SPECIAL PURPOSE RECEPTACLE; VERIFY NEMA CONFIGURATION WITH THE MANUFACTURER OF THE EQUIPMENT SERVED
 VOICE/DATA-POWER FLUSH FLOOR BOX
 DUPLEX RECEPTACLE FLUSH FLOOR BOX
 QUADRUPLEX RECEPTACLE FLUSH FLOOR BOX
 RECEPTACLE SWITCHING; EDGE SHADING INDICATES: NONE - DEVICE NOT SWITCHED LEFT - BOTTOM (DUPLEX) OR LEFT TWO (QUAD) SWITCHED RIGHT - TOP (DUPLEX) OR RIGHT TWO (QUAD) SWITCHED

PUBLIC ADDRESS
 (PROVIDE 3/4" EC WITH PULL STRING FROM THE DEVICE LOCATION SHOWN ON THE DRAWINGS TO AN ACCESSIBLE LOCATION ABOVE CEILING)

PA SYSTEM SPEAKER
 PA SYSTEM SPEAKER VOLUME CONTROL
 PA SYSTEM SPEAKER MOUNT CALL-IN SWITCH

ABBREVIATIONS

A	AMPERE(S)	CATV	CABLE TELEVISION	EF	EXHAUST FAN	FOC	FIBER OPTIC CABLE	MCB	MAIN CIRCUIT BREAKER	NO	NORMALLY OPEN	SF	SUPPLY FAN	UGS	UNDERGROUND SECONDARY
AC	ABOVE COUNTER (6" ABOVE BACKSPASH)	CB	CIRCUIT BREAKER	EGC	EQUIPMENT GROUNDING CONDUCTOR	G, GND	GROUND	CMCMKML	1,000 CIRCULAR MILS	NU	WEATHERPROOF IN USE COVER	SN	SOLID NEUTRAL	UH	UNIT HEATER
AF	AMPERE(S) FUSED	CKT	CIRCUIT	EMER	EMERGENCY	GE	GROUNDING ELECTRODE CONDUCTOR	MECH	MECHANICAL	OH	OVERHEAD	SPD	SURGE PROTECTIVE DEVICE	UL	UNDERWRITERS LABORATORY, INC.
AFCI	ARC FAULT CIRCUIT INTERRUPTER	CLG	CLG	EMT	ELECTRICAL METALLIC TUBING	GFCI	GROUND FAULT CIRCUIT INTERRUPTER	MH	MANHOLE	OHE	OVERHEAD ELECTRICAL	STD	STANDARD	UON	UNLESS OTHERWISE NOTED
AFF	ABOVE FINISHED FLOOR	CORR	CORRIDOR	EQ	EQUAL	GRS	GALVANIZED RIGID STEEL	MLO	MAIN LUGS ONLY	OSP	OUTSIDE ELECTRICAL	TEL	TELEPHONE	V	VOLTS
AFG	ABOVE FINISHED GRADE	CT	CURRENT TRANSFORMER	EQUIP.	EQUIPMENT	HH	HANDHOLE	MOPP	MAXIMUM OVERCURRENT PROTECTION	UPP	UTILITY POWER POLE	TELECOM	TELECOMMUNICATIONS	VAC	VOLTS ALTERNATING CURRENT
AIC	AMP SYMMETRICAL INTERRUPTING CAPACITY RMS	CTRL	CONTROLLER	EWC	ELECTRIC WATER COOLER	HP	HORSEPOWER	MTD	MOUNTED	PB	PULL BOX	TGB	TELECOMMUNICATIONS GROUND BUS	VDC	VOLTS DIRECT CURRENT
AT	AMPERE(S) TRIP	D	TO BE DEMOLISHED	EWH	ELECTRIC WATER HEATER	KAIC	1,000 AMP SYMMETRICAL INTERRUPTING CAPACITY RMS	MTG	MOUNTING	PH	PHASE	TMSG	TELECOMMUNICATIONS MAIN GROUND BUS	VFD	VARIABLE FREQUENCY DRIVE
AWG	AMERICAN WIRE GAUGE	DISC	DISCONNECT	EXIST.	EXISTING	KWH	1,000 WATT HOURS	NC	NORMALLY CLOSED	PNL	PANEL	TTB	TELECOM TERMINAL BOARD	WH	WATER HEATER
BG	BELOW GRADE	DIST.	DISTRIBUTION	FACP	FIRE ALARM CONTROL PANEL	KVA	1,000 VOLT AMPERES	NEC	NATIONAL ELECTRICAL CODE	PV	PHOTOVOLTAIC	TV	TELEVISION	WP	WEATHERPROOF
BLDG	BUILDING	DWG	DRAWING	FACPR	FIRE ALARM CONTROL PANEL REMOTE ANNUNCIATOR	LAN	LOCAL AREA NETWORK	NEU	NEUTRAL	PVC	POLYVINYL CHLORIDE	TVSS	TRANSIENT VOLTAGE SURGE SUPPRESSION	XPMR	TRANSFORMER
BKR	BREAKER	E	EXISTING TO REMAIN	FC	FOOTCANDLE	LC	LIGHTING CONDUCTOR	NF	NON-FUSED	QTY	QUANTITY	TYP	TYPICAL		
C	CONDUIT	EC	EMPTY CONDUIT	FCU	FAN COIL UNIT	LTG	LIGHTING	NIC	NOT IN CONTRACT	RCPT	RECEPTACLE	UG	UNDERGROUND		
CAT	CATEGORY	ECB	ENCLOSED CIRCUIT BREAKER	FLA	FULL LOAD AMPERE(S)	MCA	MINIMUM CIRCUIT AMPACITY	NL	NIGHT LIGHT	REQD	REQUIRED	UGP	UNDERGROUND PRIMARY		

TELECOMMUNICATIONS
 (JACKET COLORS TO BE PER THE OWNER'S STANDARDS IF APPLICABLE)

TELECOM TERMINAL BOARD; 0-1" THICK AC INDOOR GRADE; FIRE RETARDANT PLYWOOD, PAINTED AS SPECIFIED BY THE ARCHITECT OR OWNER
 DUPLEX DATA OUTLET; PROVIDE 1" TO AN ACCESSIBLE LOCATION ABOVE CEILING, TWO (2) BLUE CAT 6 CABLES FROM THE OUTLET TO THE TELECOM TERMINAL BOARD
 DUPLEX DATA OUTLET, AS ABOVE, MOUNTED FLUSH TO CEILING OR MOUNTED TO STRUCTURE IN AREAS WITH NO CEILING
 DUPLEX DATA OUTLET, AS ABOVE, MOUNTED ABOVE CEILING
 DATA/VOICE OUTLET; PROVIDE 1" TO AN ACCESSIBLE LOCATION ABOVE CEILING, ONE (1) BLUE AND ONE (1) WHITE CAT 6 CABLES FROM THE OUTLET TO THE TELECOM TERMINAL BOARD
 VOICE OUTLET; PROVIDE 1" TO AN ACCESSIBLE LOCATION ABOVE CEILING, ONE (1) WHITE CAT 6 CABLE FROM THE OUTLET TO THE TELECOM TERMINAL BOARD
 DUPLEX DATA FLUSH FLOOR BOX; PROVIDE 1" TO AN ACCESSIBLE LOCATION ABOVE CEILING, ONE (1) BLUE CAT 6 CABLE FROM THE OUTLET TO THE TELECOM TERMINAL BOARD
 WIRELESS ACCESS POINT (BY OWNER); PROVIDE 1" TO AN ACCESSIBLE LOCATION ABOVE CEILING, ONE (1) BLUE CAT 6 CABLE FROM THE ACCESS POINT LOCATION TO THE TELECOM TERMINAL BOARD
 LEGRAND EVOLUTION 4-GANG OR APPROVED EQUAL TV WALL BOX WITH ONE DUPLEX RECEPTACLE, ONE DUPLEX DATA OUTLET, ONE COAX OUTLET, AND ONE SPARE GANG; PROVIDE 1" TWO (2) BLUE CAT 6 CABLES AND 1" ONE (1) CATV CABLE FROM THE BOX TO THE TELECOM TERMINAL BOARD, PROVIDE CONDUIT AND WIRE FOR POWER PER THE PANEL SCHEDULE.
 LEGRAND EVOLUTION 4-GANG OR APPROVED EQUAL COMBO RECESSED FLOOR BOX WITH TWO (2) DUPLEX RECEPTABLES, FOUR (4) DATA OUTLETS (UNDER A SINGLE PLATE), AND SPEAKER CONNECTIONS; PROVIDE 1-1/4" TO AN ACCESSIBLE LOCATION ABOVE CEILING, FOUR (4) BLUE CAT 6 CABLES FROM THE BOX TO THE TELECOM TERMINAL BOARD, ROUTE 1" EC WITH PULL STRING FROM THE BOX TO THE TV WALL BOX IN THE SAME ROOM FOR SPEAKER CABLING; PROVIDE CONDUIT AND WIRE FOR POWER PER THE PANEL SCHEDULE.

LIGHTING
 (PROVIDE CONDUIT AND WIRE PER THE PANEL SCHEDULE FOR POWER AND PER THE MANUFACTURER'S SPECIFICATIONS FOR CONTROLS)

LIGHT FIXTURE; UPPERCASE LETTER(S) INDICATE FIXTURE TYPE; LOWERCASE LETTER(S) INDICATE ASSOCIATED CONTROLS ID; SEE LIGHTING FIXTURE SCHEDULE FOR FIXTURE DESCRIPTIONS AND MOUNTING TYPES
 EXIT LIGHT FIXTURE; ARROWS (IF USED) INDICATE DIRECTION; FILLED IN QUADRANT(S) INDICATE NUMBER AND ORIENTATION OF ILLUMINATED FACES; LETTER(S) INDICATE FIXTURE TYPE; SEE LIGHTING FIXTURE SCHEDULE FOR FIXTURE DESCRIPTIONS
 CEILING MOUNTED OCCUPANCY SENSOR WITH 360° COVERAGE; LOCATE AND INSTALL PER THE MANUFACTURER'S RECOMMENDATIONS; TEST AND ADJUST SENSITIVITY AFTER INSTALLATION AND SET TIME DELAY AS REQUIRED BY THE OWNER
 CEILING MOUNTED DAYLIGHT HARVESTING SENSOR, LOCATED AND INSTALLED PER THE MANUFACTURER'S RECOMMENDATIONS; TEST AND ADJUST SENSITIVITY AFTER INSTALLATION AND SET TIME DELAY AS REQUIRED PER CODE
 CEILING MOUNTED OCCUPANCY SENSOR, AS ABOVE, CONFIGURED FOR VACANCY OPERATION
 PHOTOELECTRIC CELL, EXTERIOR RATED; AIM AND SHIELD SENSOR FROM INTERIOR AND EXTERIOR ARTIFICIAL LIGHT SOURCES
 SWITCH; SUBSCRIPT (WHEN USED): NONE - SINGLE POLE TOGGLE SWITCH 3 - THREE-WAY SWITCH D - LINEAR SLIDE DIMMER SWITCH 30 - THREE-WAY LINEAR SLIDE DIMMER SWITCH O - WALL MOUNTED OCCUPANCY SENSOR 30 - THREE-WAY SWITCH WITH OCCUPANCY SENSOR a,b,c etc. - SWITCH ID

FIRE ALARM
 (PROVIDE CONDUIT AND WIRE PER THE PANEL SCHEDULE FOR POWER AND CONDUIT AND CABLING PER THE MANUFACTURER'S SPECIFICATIONS)

FIRE ALARM CONTROL PANEL
 FIRE ALARM SYSTEM PULL STATION
 FIRE ALARM SYSTEM STROBE
 FIRE ALARM SYSTEM CHIME/STROBE
 FIRE ALARM SYSTEM HORN/STROBE
 FIRE ALARM SYSTEM SPEAKER/STROBE
 FIRE ALARM SYSTEM CEILING MOUNT STROBE
 FIRE ALARM SYSTEM CEILING MOUNT CHIME/STROBE
 FIRE ALARM SYSTEM CEILING MOUNT HORN/STROBE
 FIRE ALARM SYSTEM CEILING MOUNT SPEAKER/STROBE
 FIRE ALARM SYSTEM CARBON MONOXIDE DETECTOR
 FIRE ALARM SYSTEM THERMAL DETECTOR
 FIRE ALARM SYSTEM DUCT SMOKE DETECTOR
 FIRE ALARM SYSTEM SMOKE DETECTOR

SECURITY (EQUIPMENT PROVIDED BY OWNER/OTHERS)
 (EQUIPMENT PROVIDED BY OTHERS)

JUNCTION BOX FOR KEYPAD; INSTALL 48" AFF AND PROVIDE 3/4" EC WITH PULL STRING FROM THE JUNCTION BOX TO AN ACCESSIBLE LOCATION ABOVE CEILING
 JUNCTION BOX FOR DOOR CONTACT (MAGNETIC LOCK); PROVIDE 3/4" EC WITH PULL STRING FROM THE DOOR FRAME TO THE JUNCTION BOX AND FROM THE JUNCTION BOX TO AN ACCESSIBLE LOCATION ABOVE CEILING
 JUNCTION BOX FOR CARD READER; PROVIDE 3/4" EC WITH PULL STRING FROM THE JUNCTION BOX TO AN ACCESSIBLE LOCATION ABOVE CEILING
 JUNCTION BOX FOR ELECTRIC STRIKE LOCK; PROVIDE 3/4" EC WITH PULL STRING FROM THE DOOR FRAME TO THE JUNCTION BOX AND FROM THE JUNCTION BOX TO AN ACCESSIBLE LOCATION ABOVE CEILING
 JUNCTION BOX FOR DOOR OPERATOR; PROVIDE 3/4" EC WITH PULL STRING FROM THE JUNCTION BOX TO AN ACCESSIBLE LOCATION ABOVE CEILING NEAR THE CONTROLLED DOOR
 JUNCTION BOX FOR MOTION DETECTOR; PROVIDE 3/4" EC WITH PULL STRING FROM THE JUNCTION BOX TO AN ACCESSIBLE LOCATION ABOVE CEILING
 JUNCTION BOX FOR CEILING MOUNTED CAMERA; PROVIDE 3/4" EC WITH PULL STRING FROM THE JUNCTION BOX TO AN ACCESSIBLE LOCATION ABOVE CEILING
 JUNCTION BOX FOR WALL MOUNTED CAMERA; PROVIDE 3/4" EC WITH PULL STRING FROM THE JUNCTION BOX TO AN ACCESSIBLE LOCATION ABOVE CEILING

SOUND
 (PROVIDE 1" EC WITH PULL STRING FROM THE DEVICE LOCATION SHOWN ON THE DRAWINGS TO AN ACCESSIBLE LOCATION ABOVE CEILING)

FLOOR MOUNTED MICROPHONE OUTLET
 CEILING MOUNTED SPEAKER
 WALL MOUNTED SPEAKER

HEALTH CARE
 (PROVIDE 1" EC WITH PULL STRING FROM THE DEVICE LOCATION SHOWN ON THE DRAWINGS TO AN ACCESSIBLE LOCATION ABOVE CEILING)

DOCTOR'S DICTATION
 NURSE CALL SYSTEM EMERGENCY CALL-IN STATION
 NURSE CALL SYSTEM BEDSIDE PATIENT STATION
 NURSE CALL SYSTEM STAFF STATION
 NURSE CALL SYSTEM CORRIDOR DOME LIGHT
 NURSE CALL SYSTEM CODE BLUE STATION

ELECTRICAL GENERAL NOTES

- ALL ELECTRICAL WORK SHALL BE DONE IN STRICT ACCORDANCE WITH THE LATEST EDITION OF THE NATIONAL ELECTRICAL CODE AS ADOPTED BY THE AHJ.
- THE WORDS "PROVIDE" AND "PROVIDE AS SHOWN" AS USED HEREIN SHALL BE UNDERSTOOD TO MEAN, "PROVIDE COMPLETE IN PLACE," THAT IS "FURNISH AND INSTALL." EQUIPMENT AND MATERIAL INDICATED TO BE PROVIDED SHALL BE NEW UNLESS OTHERWISE NOTED AND SHALL BE OF THE MOST SUITABLE GRADE FOR THE PURPOSE INTENDED.
- ROUTE NEW CONDUIT AND WIRING CONCEALED IN WALLS AND CEILING WHERE POSSIBLE. COORDINATE INSTALLATION OF EXPOSED CONDUIT AND WIRING WITH THE ARCHITECT.
- CONTRACTOR SHALL PROVIDE ELECTRICAL SERVICE TO NEW HVAC UNITS AS FURNISHED BY THE MECHANICAL CONTRACTOR. VERIFY THE EXACT ELECTRICAL REQUIREMENTS WITH THE REVISED HVAC SUBMITTALS PRIOR TO ORDERING ELECTRICAL EQUIPMENT.
- BEFORE INSTALLATION, CONTRACTOR SHALL SUBMIT DETAILED DRAWINGS TO THE ENGINEER FOR REVIEW COVERING PROPOSED LOCATIONS, MOUNTING, AND ROUTING FOR ALL CONDUITS, SERVICES, FITTINGS, GROUND RODS, SUPPORTS, ETC.
- CONTRACTOR IS RESPONSIBLE FOR OVER-CURRENT PROTECTIVE DEVICE SHORT CIRCUIT, COORDINATION, AND ARC-FLASH STUDIES.
- MATERIALS AND MANUFACTURERS NOTED ON DRAWINGS ARE TO BE USED AS BASIS OF DESIGN TO ESTABLISH QUALITY AND PERFORMANCE STANDARDS AND SHALL BE PROVIDED AS SPECIFIED. SUBSTITUTIONS WILL BE CONSIDERED WHERE SUFFICIENT PRODUCT INFORMATION IS PROVIDED TO MAKE A PROPER EVALUATION. REVIEW OF A SUBSTITUTION IS AT THE SOLE DISCRETION OF THE PROFESSIONAL.
- THE CONTRACTOR SHALL SUBMIT COPIES OF THE PRODUCT DATA, SHOP DRAWINGS, ETC. OF ALL MATERIALS NOTED ON THE DRAWINGS. ALL SUBMITTED PRODUCT DATA, SHOP DRAWINGS, ETC. SHALL BE MARKED WITH THE NAME OF THE PROJECT AND SHALL BEAR THE STAMP OF APPROVAL OF THE CONTRACTOR AS EVIDENCE THAT THE MATERIAL HAS BEEN CHECKED BY THE CONTRACTOR.
- DRAWINGS SPECIFIC TO THIS TRADE DO NOT LIMIT THE RESPONSIBILITY OR WORK REQUIRED BY THE CONTRACT DOCUMENTS. REFER TO DRAWINGS AND SPECIFICATIONS OF OTHER TRADES FOR COMPLETE INFORMATION PRIOR TO BID.
- WHERE CONFLICTS EXIST AMONG DRAWINGS, SPECIFICATIONS, AND EQUIPMENT SCHEDULES, THE MOST STRINGENT REQUIREMENT OR QUANTITY SHALL APPLY. NOTIFY THE ARCHITECT/ENGINEER OF ALL CONFLICTS FOR RESOLUTION OR INTERPRETATION.
- NO EQUIPMENT SHALL BE ORDERED OR INSTALLED UNTIL THE PROJECT ENGINEER HAS RECEIVED A COPY STAMPED "NO EXCEPTIONS TAKEN." NO EXCEPTIONS TAKEN DOES NOT RELIEVE THE CONTRACTOR FROM CONFORMANCE WITH THE CONTRACT. EXTEND TO QUANTITIES OR DIMENSIONS, IMPLY THAT THE EQUIPMENT CAN BE INSTALLED OR OPERATE SATISFACTORILY, THAT THE EQUIPMENT CONTAINS ALL NECESSARY COMPONENTS, OR THAT IT WILL COORDINATE WITH OTHER REVIEWED ITEMS.
- OMISSION FROM THIS SHEET OF ANY ITEM SHOWN ELSEWHERE IN THE PLANS DOES NOT RELIEVE THE CONTRACTOR FROM THE RESPONSIBILITY FOR ANY ASSOCIATED WORK.
- COORDINATE INSTALLATION OF NEW ITEMS AND EQUIPMENT WITH THE OWNER'S REPRESENTATIVE AND THE WORK OF OTHER TRADES. THE CONTRACTOR SHALL INCUR ALL COSTS ASSOCIATED WITH THE RELOCATION OF EQUIPMENT CONFLICTING WITH NEW WORK BY OTHER TRADES THAT HAS NOT BEEN COORDINATED.
- COORDINATE ALL ASPECTS OF NEW SERVICE WITH UTILITY COMPANY AND INCLUDE ALL COSTS IN BID.
- WARNING TAPE SHALL BE INSTALLED 12 TO 18 INCHES BELOW GRADE OVER ALL CONDUITS.
- PROVIDE 1/4" MINIMUM DIAMETER PULL ROPE. PULL ROPE SHALL NOT BE NYLON STRING.
- FOR SERVICE ENTRANCE CONDUITS, UTILIZE LONG RADIUS (3R) CONDUIT BENDS.
- ALL CONDUIT RISERS FROM UNDERGROUND SHALL HAVE RIGID METAL ELBS AND RISERS.
- PRIOR TO CONSTRUCTION, VERIFY THE LOCATION OF ALL EXISTING UNDERGROUND UTILITIES. AVOID DISTURBANCE OF EXISTING UTILITIES NOT INCLUDED IN THIS PROJECT.
- SET SCREW CONDUIT FITTINGS SHALL NOT BE PERMITTED.

LIGHTING GENERAL NOTES

- VERIFY THE EXACT LOCATION OF ALL LIGHTING SWITCHES WITH THE ARCHITECT PRIOR TO ROUGH-IN.
- VERIFY THE EXACT LOCATION OF ALL LIGHTING FIXTURES WITH THE ARCHITECTURAL REFLECTED CEILING PLAN PRIOR TO ROUGH-IN.
- VERIFY THE EXACT LOCATION OF CEILING MOUNTED OCCUPANCY SENSORS WITH THE MANUFACTURER'S SPECIFICATIONS PRIOR TO INSTALLATION FOR MAXIMUM PERFORMANCE.
- EMERGENCY FIXTURES AND EXIT FIXTURES SHALL BE CONNECTED TO THE NEAREST LIGHTING CIRCUIT. BRANCH CIRCUIT WIRING TO EXIT FIXTURES AND TO BATTERY INVERTERS WITHIN FIXTURES WITH INTEGRAL BATTERY UNITS SHALL BE UNSWITCHED, CONNECTED AHEAD OF ANY CONTROL SWITCHING.
- WALL MOUNT TYPE "2" FIXTURES ABOVE DOOR AS SHOWN ON DRAWINGS. COORDINATE WITH THE ARCHITECT PRIOR TO ROUGH-IN.
- MOUNT TYPE "EM" FIXTURES 8'-0" AFF UNLESS OTHERWISE NOTED.
- VERIFY THE CEILING TYPES FOR ALL LIGHT FIXTURES TO BE FLUSH MOUNTED OR SUSPENDED AND ADJUST FIXTURE MOUNTING TYPES IN ACCORDANCE WITH THE CEILING TYPE, AS REQUIRED. CONTRACTOR SHALL PROVIDE ALL REQUIRED MOUNTING HARDWARE.
- ALL VANTIX FIXTURES SHALL BE MOUNTED WITH 0-3" OF SPACE BETWEEN THE BOTTOM OF THE FIXTURE AND THE TOP OF THE MIRROR UNLESS OTHERWISE NOTED.
- VERIFY THE EXACT MOUNTING LOCATION FOR ANY PHOTOELECTRIC CELLS WITH THE ARCHITECT PRIOR TO ROUGH-IN.
- ALL PHOTOELECTRIC CELLS MUST FACE NORTH.
- CONTRACTOR SHALL CONFIRM COMPATIBILITY OF ALL LIGHTING CONTROL DEVICES/SWITCHES/DIMMERS WITH LIGHTING FIXTURES AND BALLASTS/DRIVERS PRIOR TO SUBMITTAL.
- COORDINATE LOCATION OF LIGHT FIXTURES IN MECHANICAL ROOMS WITH DIVISION 15/23 PLANNED EQUIPMENT LOCATION AND DUCT INSTALLATION. WALL MOUNT LIGHTS OR PROVIDE PENDANT MOUNTING AS REQUIRED TO ILLUMINATE THE SPACE.
- WHERE MULTIPLE OCCUPANCY SENSORS ARE SHOWN IN THE SAME AREA, MOTION DETECTION BY ONE SENSOR SHALL ILLUMINATE ALL LIGHTING IN THE RESPECTIVE AREA.

TELECOMMUNICATIONS GENERAL NOTES

- PROVIDE 1" CONDUIT AND TWO (2) CAT 6 CABLES AT EACH DATA OUTLET SHOWN. ROUTE TO ABOVE CEILING AND ROUTE TO TELEPHONE BACKBOARD IN IT ROOM. TERMINATE AND CONNECT STATION CABLES TO PATCH PANEL, FOLLOWING THE OWNER'S LABELING CONVENTIONS FOR ALL HORIZONTAL CABLING.
- OWNER SHALL PROVIDE THE WALL MOUNT DATA RACK, ALL ITEMS INCLUDED IN THE DATA RACK, AND ANY NECESSARY TELEPHONE EQUIPMENT.
- PLYWOOD FOR BACKBOARDS SHALL BE 0-1" AC INDOOR GRADE, FIRE RETARDANT, AND PAINTED AS SPECIFIED. COMMON BOND RACKS, PATCH PANELS, CABLE SHIELDS, PROTECTORS, AND THE BUILDING MAIN ELECTRICAL GROUNDING CONDUCTORS SHALL BE, AT MINIMUM, #6 AWG INSULATED AND STRANDED COPPER. FASTENERS SHALL BE RECESSED AND ANCHORED.
- SUBMIT DIGITAL PHOTOGRAPHS OF ALL TERMINATIONS TO MAIN ELECTRICAL SERVICE GROUNDING MEANS.
- ALL BACKBOARDS SHALL BE EQUIPPED WITH D-RINGS SPACED AT 1'-0" APART AROUND ALL EDGES OF THE PLYWOOD TO SUPPORT CABLE AND WIRE.
- CAT 6 CABLES FOR DATA OUTLETS SHALL HAVE BLUE JACKETS AND CAT 6 CABLES FOR VOICE OUTLETS SHALL HAVE WHITE JACKETS.

SPECIAL SYSTEMS GENERAL NOTES

- VERIFY EXACT LOCATION, VOLTAGE, PHASE, AMPERAGE, ETC. OF ALL MECHANICAL EQUIPMENT WITH MECHANICAL CONTRACTOR PRIOR TO ORDERING ELECTRICAL GEAR.
- INTERCONNECT THE HOOD EXHAUST AND SUPPLY FANS WITH HOOD EXTINGUISHING SYSTEM SUCH THAT WHEN HOOD EXTINGUISHING SYSTEM IS ACTIVATED, THE EQUIPMENT BELOW THE HOOD AND HOOD SUPPLY FAN ARE DE-ENERGIZED AND THE HOOD EXHAUST FAN WILL START IF NOT RUNNING.
- INTERCONNECT THE HOOD EXTINGUISHING SYSTEM WITH THE FIRE ALARM SYSTEM IF APPLICABLE.
- FOR ALL CAMERA LOCATIONS, PROVIDE ONE (1) GREEN JACKETED CAT 6 CABLE IN 3/4" CONDUIT BACK TO ASSOCIATED DATA CLOSET.
- FOR ALL WIRELESS ACCESS POINT LOCATIONS, PROVIDE ONE (1) YELLOW JACKETED CAT 6 CABLE IN 3/4" CONDUIT BACK TO ASSOCIATED DATA CLOSET.
- PROVIDE AN ADDITIONAL 10% OR ONE (1), WHICHEVER IS GREATER, OF THE FOLLOWING DEVICES WHICH ARE INCLUDED IN THE PROJECT, AND INSTALL THEM AT THE DIRECTION OF THE ARCHITECT, ENGINEER, OR AHJ DURING THE COURSE OF THE PROJECT. PROVIDE ALL REQUIRED CONDUIT, INTERCONNECTIONS, CONDUITS, PROGRAMMING, ETC. AS REQUIRED AT NO ADDITIONAL COST TO THE OWNER. INITIATING DEVICES (PULL STATIONS, SMOKE DETECTORS, THERMAL DETECTORS, ETC.), NOTIFICATION APPLIANCES (STROBES, HORN STROBES, SPEAKER STROBES, SPEAKERS, DUCT DETECTORS, ETC.), AND MONITORING MODULES.
- VERIFY REQUIRED QUANTITY OF DUCT DETECTORS WITH DUCTWORK CONFIGURATION AS IT IS ACTUALLY INSTALLED. COORDINATE WITH MECHANICAL CONTRACTOR PRIOR TO ROUGH-IN.

DEMOLITION GENERAL NOTES

- THE LOCATIONS OF EXISTING CIRCUITS AND EQUIPMENT ARE SHOWN IN AN APPROXIMATE WAY ONLY AND HAVE NOT BEEN INDEPENDENTLY VERIFIED BY THE OWNER OR ITS REPRESENTATIVE. THE CONTRACTOR SHALL DETERMINE THE EXACT LOCATION OF ALL EXISTING ELECTRICAL DEVICES, EQUIPMENT, AND WIRING BEFORE COMMENCING WORK AND AGREE TO BE FULLY RESPONSIBLE FOR ANY AND ALL DAMAGES WHICH MIGHT BE CAUSED BY THE CONTRACTOR'S FAILURE TO EXACTLY LOCATE AND PRESERVE ANY AND ALL EXISTING PORTIONS OF THE ELECTRICAL SYSTEMS.
- THE CONTRACTOR SHALL REMOVE SUCH EXISTING WORK AS CALLED FOR ON THE DRAWINGS OR AS REQUIRED TO CLEAR THE AREAS OF NEW CONSTRUCTION.
- ALL EQUIPMENT REMOVED THAT IS NOT BEING REUSED SHALL REMAIN THE PROPERTY OF THE OWNER OR SHALL BE DISPOSED OF AS REQUIRED.
- EXCEPT AS OTHERWISE NOTED, ALL EXISTING ELECTRICAL WORK WHICH WILL NOT BE RENDERED OBSOLETE AND WHICH MAY BE DISTURBED DUE TO ANY CHANGES REQUIRED UNDER THIS CONTRACT, SHALL BE RESTORED TO ITS ORIGINAL OPERATING CONDITION. OTHER ELECTRICAL WORK OR MATERIAL RENDERED OBSOLETE SHALL BE ABANDONED WHERE CONCEALED AND REMOVED WHERE EXPOSED. OLD, UNUSED WIRING AND DEVICES SHALL BE REMOVED FROM THE ABANDONED (CONCEALED) CONDUITS OUTLETS SHALL BE PROVIDED WITH BLANK COVERS. ANY CONDUITS STUBBED OUT OF MASONRY SHALL BE RECESSED AND PATCHED.
- WHERE EXISTING ELECTRICAL WORK INTERFERES WITH NEW WORK AND WHERE SUCH INSTALLATIONS ARE TO REMAIN IN USE, THE INSTALLATIONS SHALL BE DISCONTINUED AND RELOCATED AND/OR RECONNECTED TO COORDINATE WITH THE WORK INDICATED ON THE CONTRACT DRAWINGS AS SPECIFIED.
- WHERE EXISTING RACEWAYS THAT ARE NOT TO BE REUSED INTERFERE WITH NEW WORK, THESE RACEWAYS SHALL BE REMOVED BACK TO THE NEAREST JUNCTION BOX OR PULL BOX AND THE OPENINGS BLANKED.
- CONTRACTOR SHALL MAINTAIN CONTINUITY OF BRANCH CIRCUITS SERVING MULTIPLE ITEMS OF WHICH ONE OR MORE ARE BEING DEMOLISHED. CONDUCTORS AND CONDUITS FOR THOSE ITEMS BEING DEMOLISHED SHALL BE REMOVED AS FAR AS PRACTICABLE.
- IT SHALL BE THE CONTRACTOR'S RESPONSIBILITY TO REMOVE ALL EXISTING ELECTRICAL EQUIPMENT AND DATA WIRING NOT REUSED OR NOT NECESSARY FOR THE COMPLETION OF THIS PROJECT.
- WHERE NEW LOADS ARE CONNECTED TO EXISTING PANELS, AND WHERE LOADS ARE REARRANGED IN EXISTING PANELS AS PART OF THIS PROJECT, UPDATE THE RESPECTIVE PANEL DIRECTORY SO AS TO PROVIDE A COMPLETE, ACCURATE, AND TYPED WRITTEN PANEL SCHEDULE. THE NEW PANEL SCHEDULE SHALL INCORPORATE ALL EXISTING LOADS, INCLUDING LOADS "EXISTING TO REMAIN". PROVIDE ALL REQUIRED TESTING AND INVESTIGATIONS NECESSARY TO ACCOMPLISH THIS WORK.
- COORDINATE THE REMOVAL AND REINSTALLATION (OR PROTECTION IN PLACE) OF EXISTING ELECTRICAL EQUIPMENT AND DEVICES WITH THE WORK OF OTHER TRADES TO REPLACE OR REFINISH EXISTING WALLS AND CEILINGS.
- WHERE EXISTING CIRCUITS ARE BEING REMOVED IN EXISTING PANELS, PROVIDE A NEW, NEATLY TYPED DIRECTORY WHICH INDICATES WHERE "SPARE" BREAKERS ARE LOCATED. ANY EXISTING BREAKERS THAT ARE NOT FEEDING DEVICES SHALL REMAIN AND BE LABELED AS A "SPARE."
- WHERE NEW LOADS ARE CONNECTED TO EXISTING PANELS, AND WHERE LOADS ARE REARRANGED IN EXISTING PANELS AS PART OF THIS PROJECT, UPDATE THE RESPECTIVE PANEL DIRECTORY SO AS TO PROVIDE A COMPLETE, ACCURATE, AND TYPED WRITTEN PANEL SCHEDULE. THE NEW PANEL SCHEDULE SHALL INCORPORATE ALL EXISTING LOADS, INCLUDING LOADS "EXISTING TO REMAIN". PROVIDE ALL REQUIRED TESTING AND INVESTIGATIONS NECESSARY TO ACCOMPLISH THIS WORK.


INDEX - ELECTRICAL SHEETS

E0.0	ELECTRICAL COVER SHEET
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E2.1	FIELD PHOTOMETRICS
E3.0	RISER DIAGRAM & SCHEDULES
E4.0	ELECTRICAL DETAILS



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PROJECT INFORMATION

QUALITY ENG. PRAIRYVILLE PARK
 FIELD LIGHTING

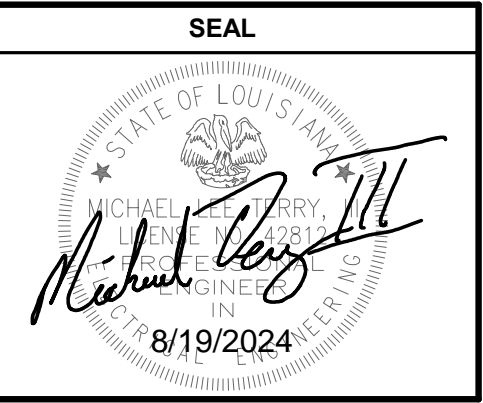38430 LA-929, PRAIRYVILLE, LA 70769

REVISIONS

SHEET INFORMATION

DATE:	10/4/2024
DRAWN BY:	HJM
CHECKED BY:	CC
PROJECT #:	24-067

SHEET NAME

ELECTRICAL COVER SHEET

SHEET NUMBER

E0.0

ALL SYMBOLS, ABBREVIATIONS, AND NOTES ABOVE ARE TYPICAL AND ARE NOT NECESSARILY USED IN THESE CONSTRUCTION DOCUMENTS

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SEAL

STATE OF LOUISIANA
MICHAEL ROY JILL
REGISTERED PROFESSIONAL ENGINEER
IN THE STATE OF LOUISIANA
8/19/2024

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PROJECT INFORMATION

**QUALITY ENG. PRAIRYVILLE PARK
FIELD LIGHTING**

38430 LA-929, PRAIRIEVILLE, LA 70769

REVISIONS

NO.	DESCRIPTION	DATE

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PROJECT #:	24-067

SHEET NAME
**ELECTRICAL DEMOLITION
PLAN**

SHEET NUMBER
E0.1


DEMOLITION KEYNOTES:

- ① EXISTING POLE, SPORTING LIGHT FIXTURES, CONDUIT, AND SPEAKERS/ SPEAKER WIRING (IF APPLICABLE) TO BE REMOVED (TYPE FOR 8)



1 DEMO POWER PLAN
1" = 30'-0"

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SHEET NAME

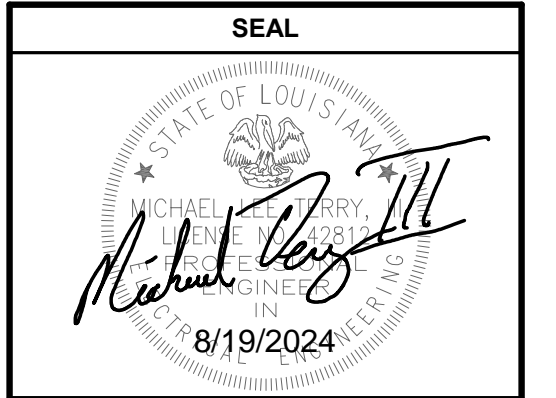
POWER PLAN

SHEET NUMBER

E1.0

POWER PLAN KEYNOTE:


- PROVIDE AND INSTALL NEW JUNCTION BOX AND 3/4" C, 2#12 THWN & #12 GND FOR EACH AUTOMATIC FLUSH VALVE. TERMINATE TO NEW 120V/20A/1P BREAKER IN NEW PANEL "LA". COORDINATE EXACT LOCATION WITH PLUMBING CONTRACTOR PRIOR TO ROUGH-IN. (TYP. FOR THREE)

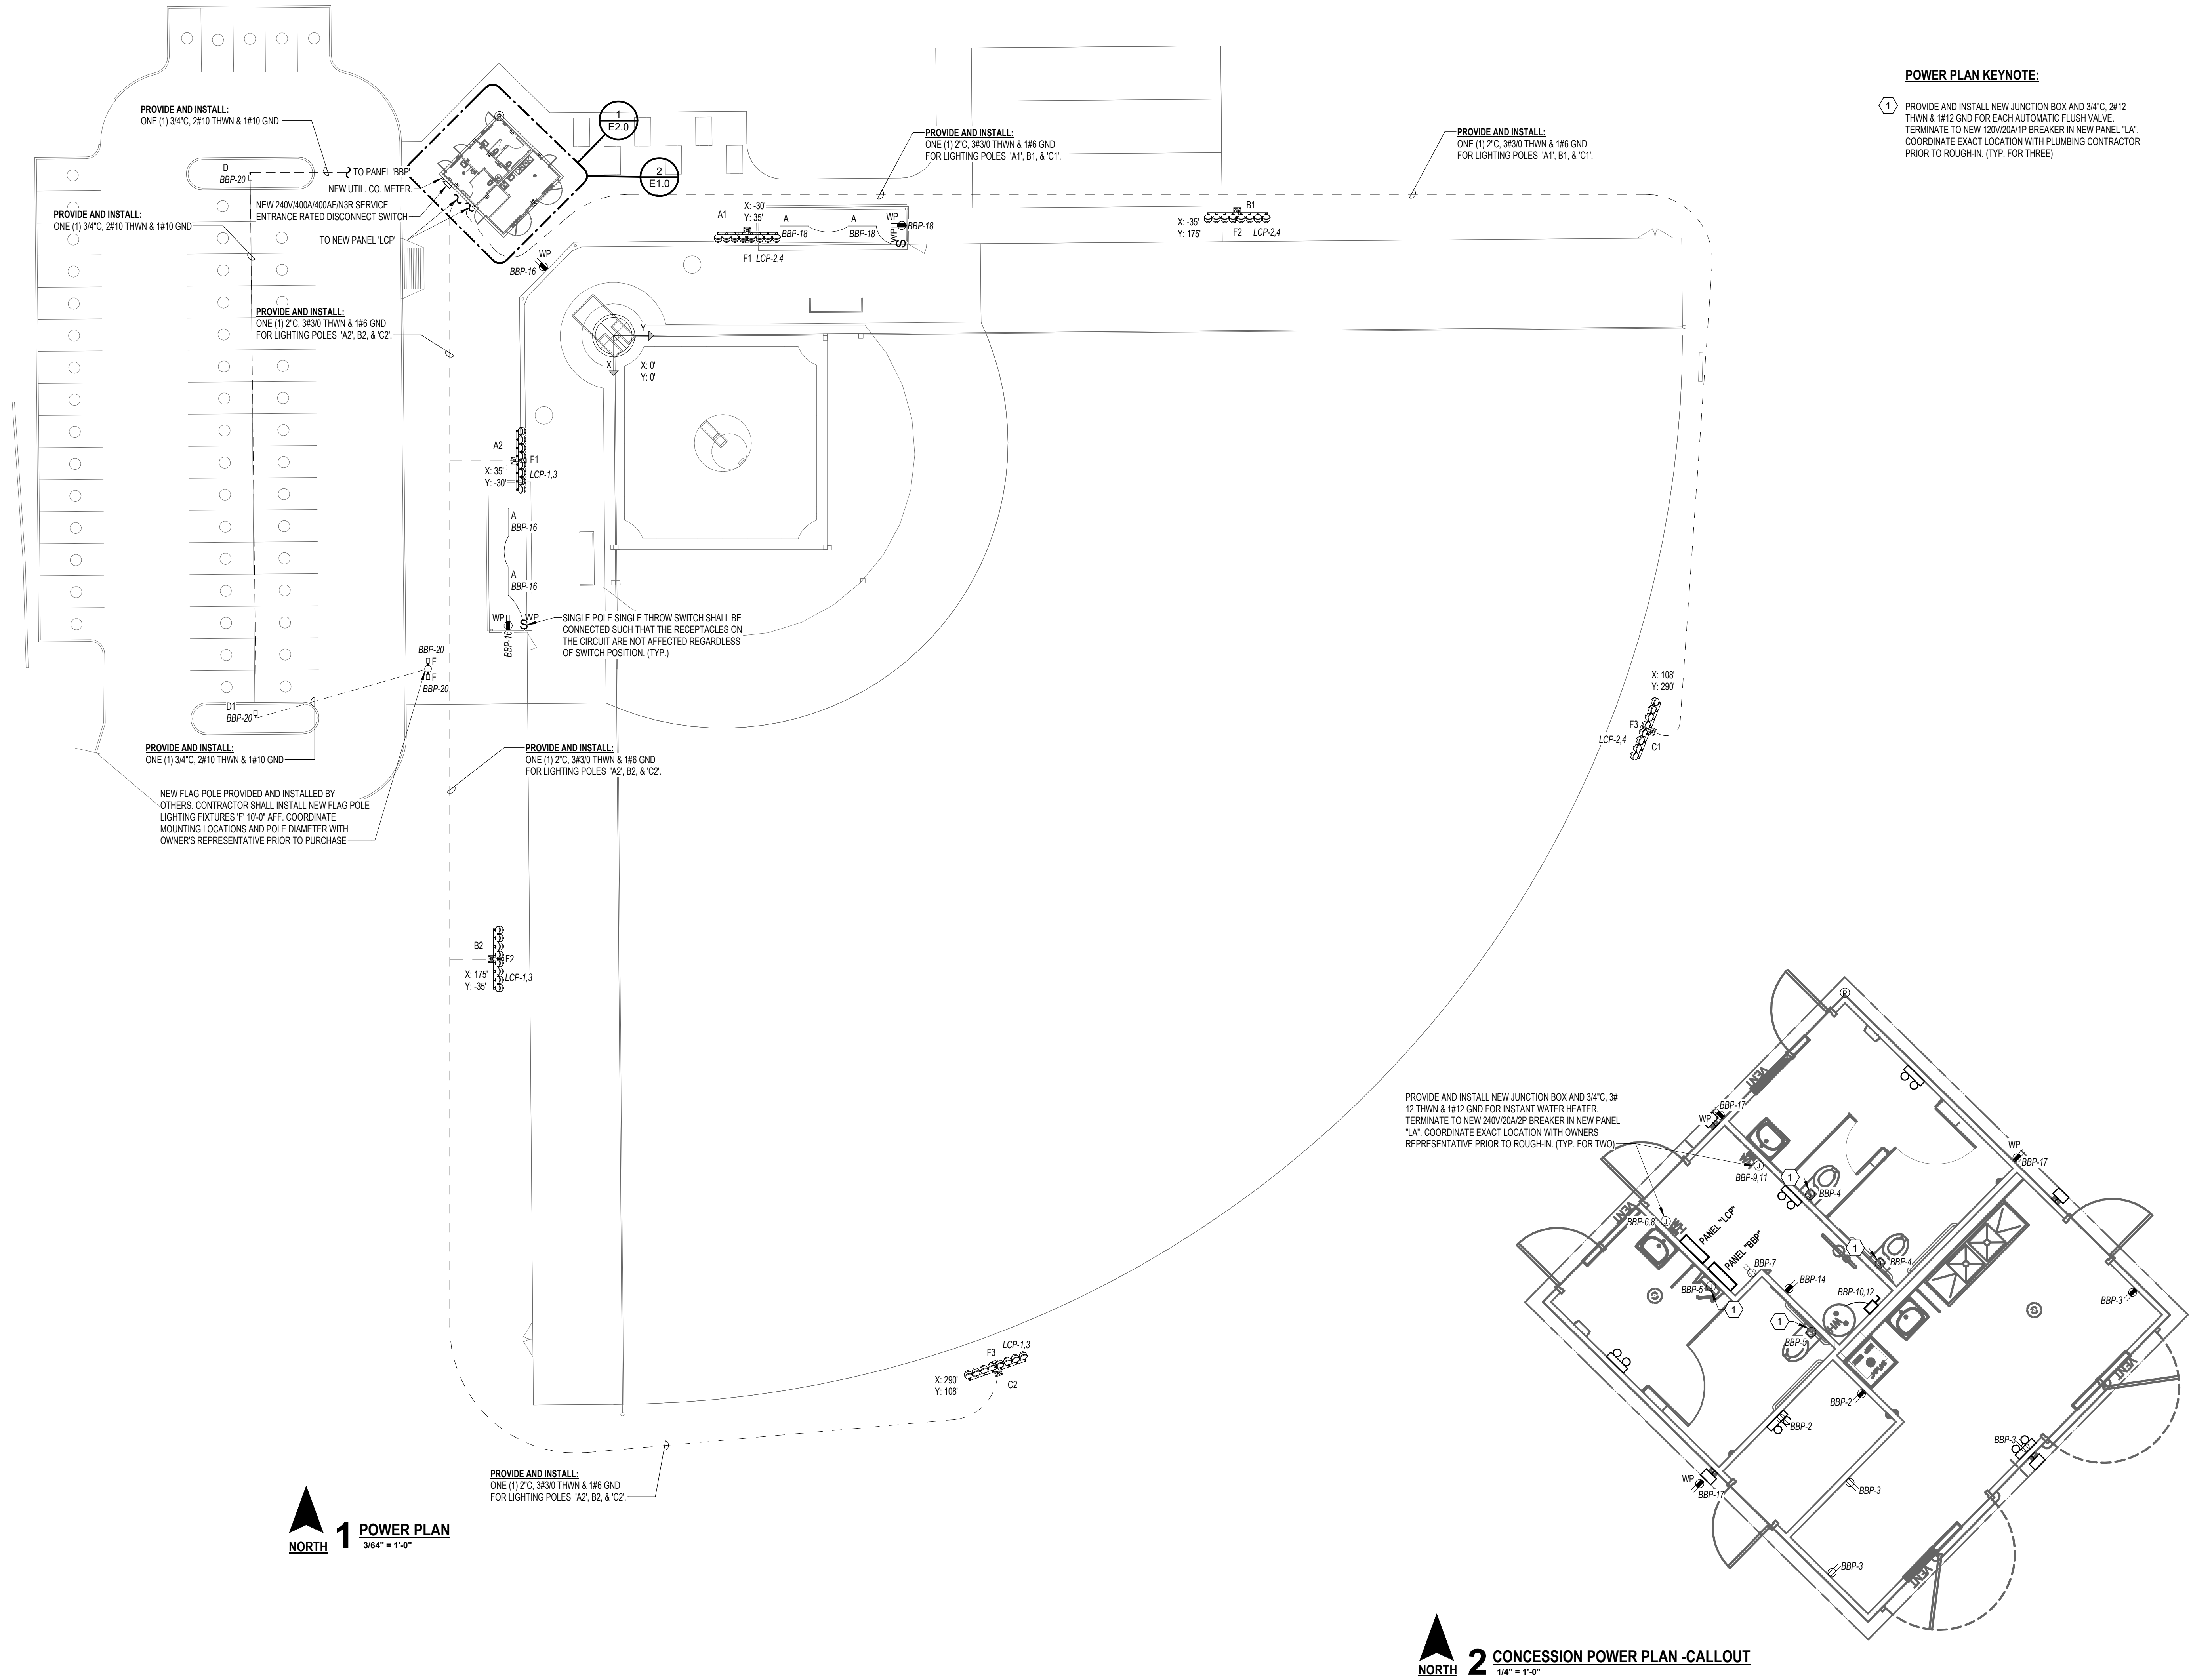

1 POWER PLAN
3/64" = 1'-0"

2 CONCESSION POWER PLAN -CALLOUT
1/4" = 1'-0"

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PROJECT INFORMATION

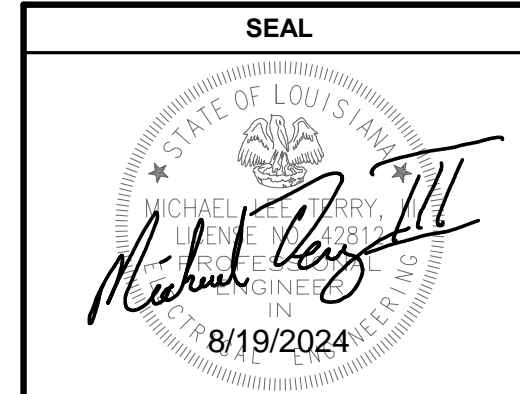**QUALITY ENG. PRAIRYVILLE PARK
FIELD LIGHTING**

38430 LA-829, PRAIRIEVILLE, LA 70769

REVISIONS

NO.	DESCRIPTION

SHEET INFORMATION

DATE:	10/4/2024
DRAWN BY:	HJM
CHECKED BY:	CC
PROJECT #:	24-067

SHEET NAME

LIGHTING PLAN


SHEET NUMBER

E2.0

SCHEDULE - CONCESSION LIGHTING FIXTURES

NOTES:
** FINISH TO BE SELECTED BY ARCHITECT


MARK	DESCRIPTION	LAMPS	VOLTS	LOAD	TEMP.	LUMENS	MOUNTING	BASIS OF DESIGN		COUNT
								MANUFACTURER	CATALOG NO.	
A	8' LED STRIP LIGHT WITH SEMI-FROSTED LENS. PROVIDE SUSPENSION HARDWARE AS REQUIRED.	LED	120V	37 VA	4000K	6,000	CEILING	LITHONIA LIGHTING	CLX-L96-6000LM-SEF-FDL-MVOLT-GZ10-040K-80CRI**	10
B	4' LED STRIP LIGHT WITH SEMI-FROSTED LENS. PROVIDE SUSPENSION HARDWARE AS REQUIRED.	LED	120V	30 VA	4000K	5,000	CEILING	LITHONIA LIGHTING	CLX-L48-5000LM-SEF-FDL-MVOLT-GZ10-040K-80CRI**	3
C	ARCHITECTURAL LED WALL PACK	LED	120V	50 VA	4000K	3,000	WALL	LITHONIA LIGHTING	WST-P2-40K-MVOLT	4
D	LED PARKING LOT FIXTURE SHALL BE MOUNTED ON POLE AT 25'-0" AFF	LED	120V	51 VA	4000K	7,400	POLE	LITHONIA LIGHTING	DSX1-LED-P1-40K-80CRI-TFTM-MVOLT-SPAS-PIR**	1
D1	LED PARKING LOT FIXTURE SHALL BE MOUNTED ON POLE AT 25'-0" AFF	LED	120V	51 VA	4000K	7,390	POLE	LITHONIA LIGHTING	DSX1-LED-P1-40K-80CRI-T4M-MVOLT-SPAS-PIR**	1
EM	EMERGENCY LIGHTING UNIT EQUIPMENT WITH TWO ADJUSTABLE LED HEADS. INTEGRAL BATTERY WITH SELF-DIAGNOSTICS.	LED	120V	2 VA	4000K	1,100	WALL	LITHONIA LIGHTING	ELM6L	5
F	LED WEATHERPROOF FLAG POLE LIGHTING FIXTURE. CONTRACTOR SHALL MOUNT FIXTURE 10'-0" AFF ON POLE. COORDINATE POLE DIAMETER WITH OWNER'S REPRESENTATIVE PRIOR TO PURCHASE.	LED	120V	58 VA	4000K	5,000	POLE	KIRLIN LIGHTING	LWR-09490-5000L-120**	2

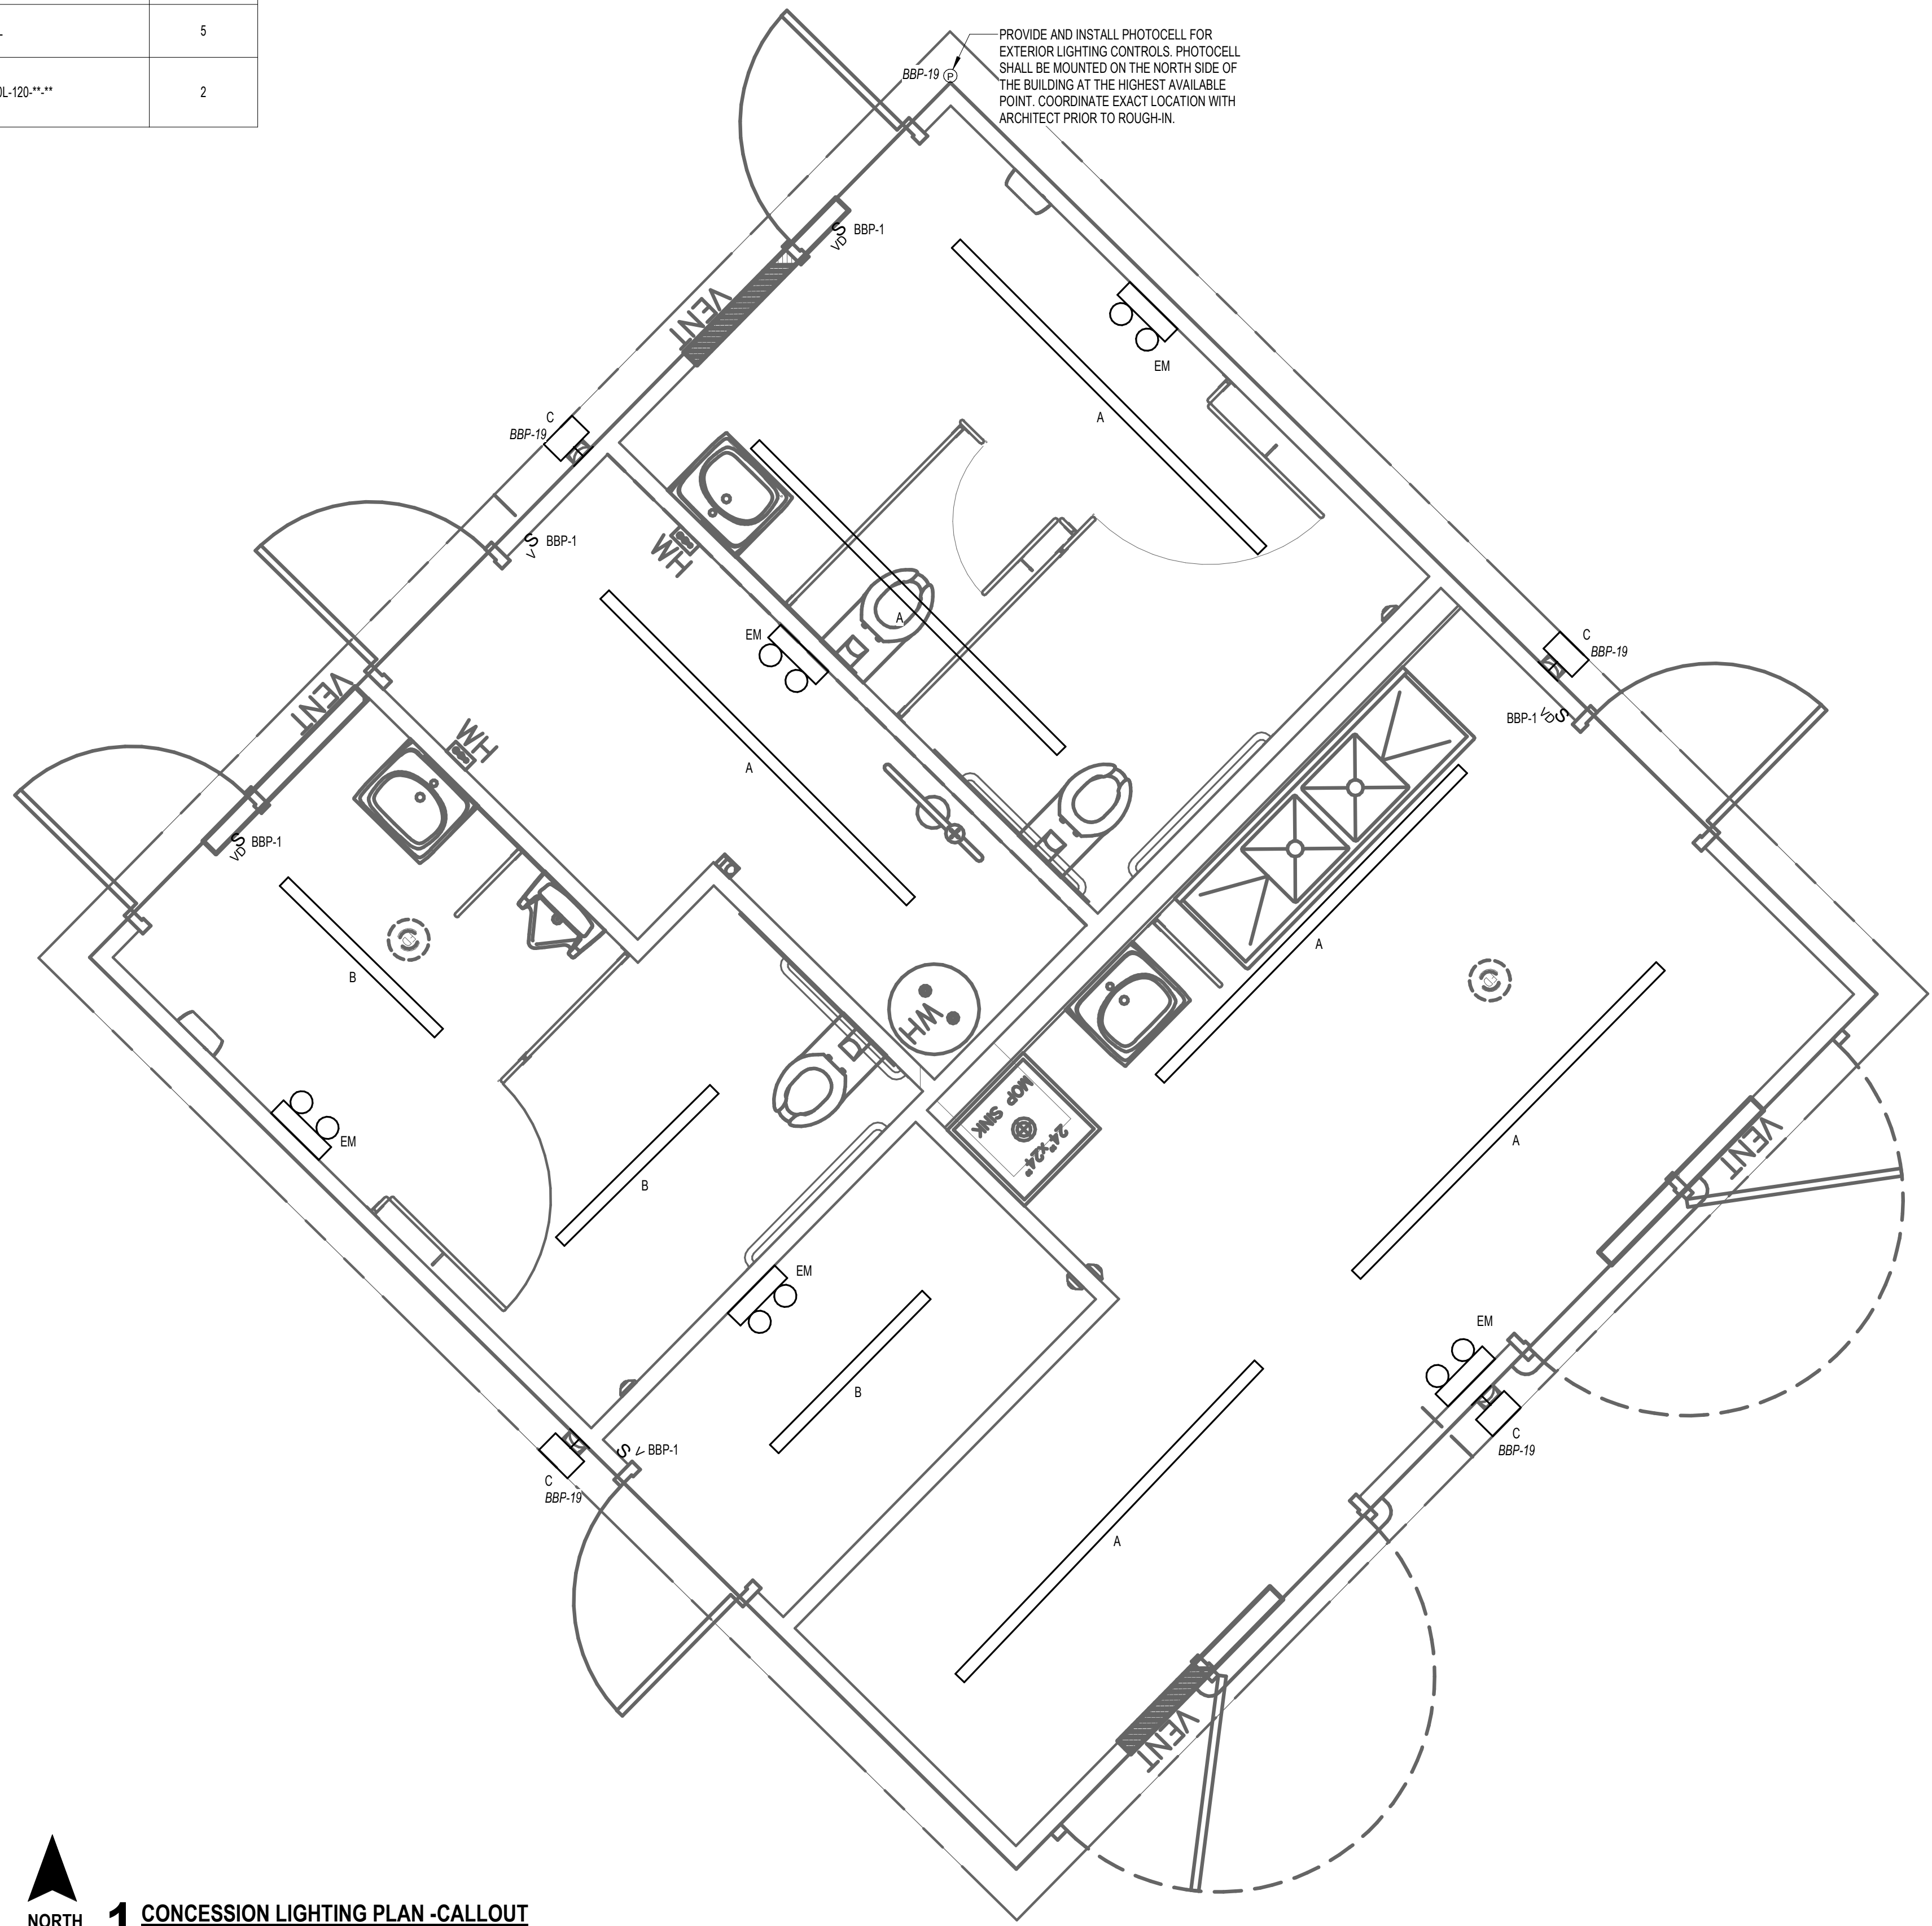

NORTH

1 CONCESSION LIGHTING PLAN -CALLOUT
1/2" = 1'-0"

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PROJECT INFORMATION

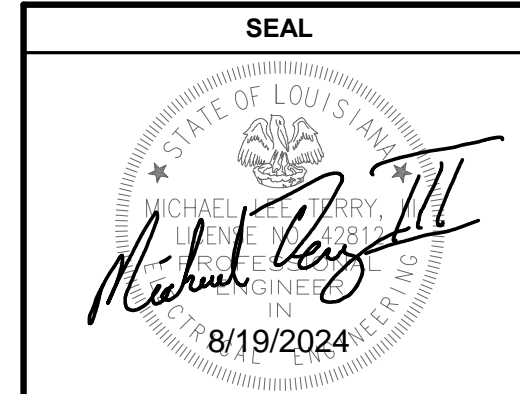**QUALITY ENG. PRAIRYVILLE PARK
FIELD LIGHTING**

38430 LA-829, PRAIRIEVILLE, LA 70769

REVISIONS

NO.	DESCRIPTION

SHEET INFORMATION


DATE:	10/4/2024
DRAWN BY:	HJM
CHECKED BY:	CC
PROJECT #:	24-067

SHEET NAME

FIELD PHOTOMETRICS

SHEET NUMBER

E2.1

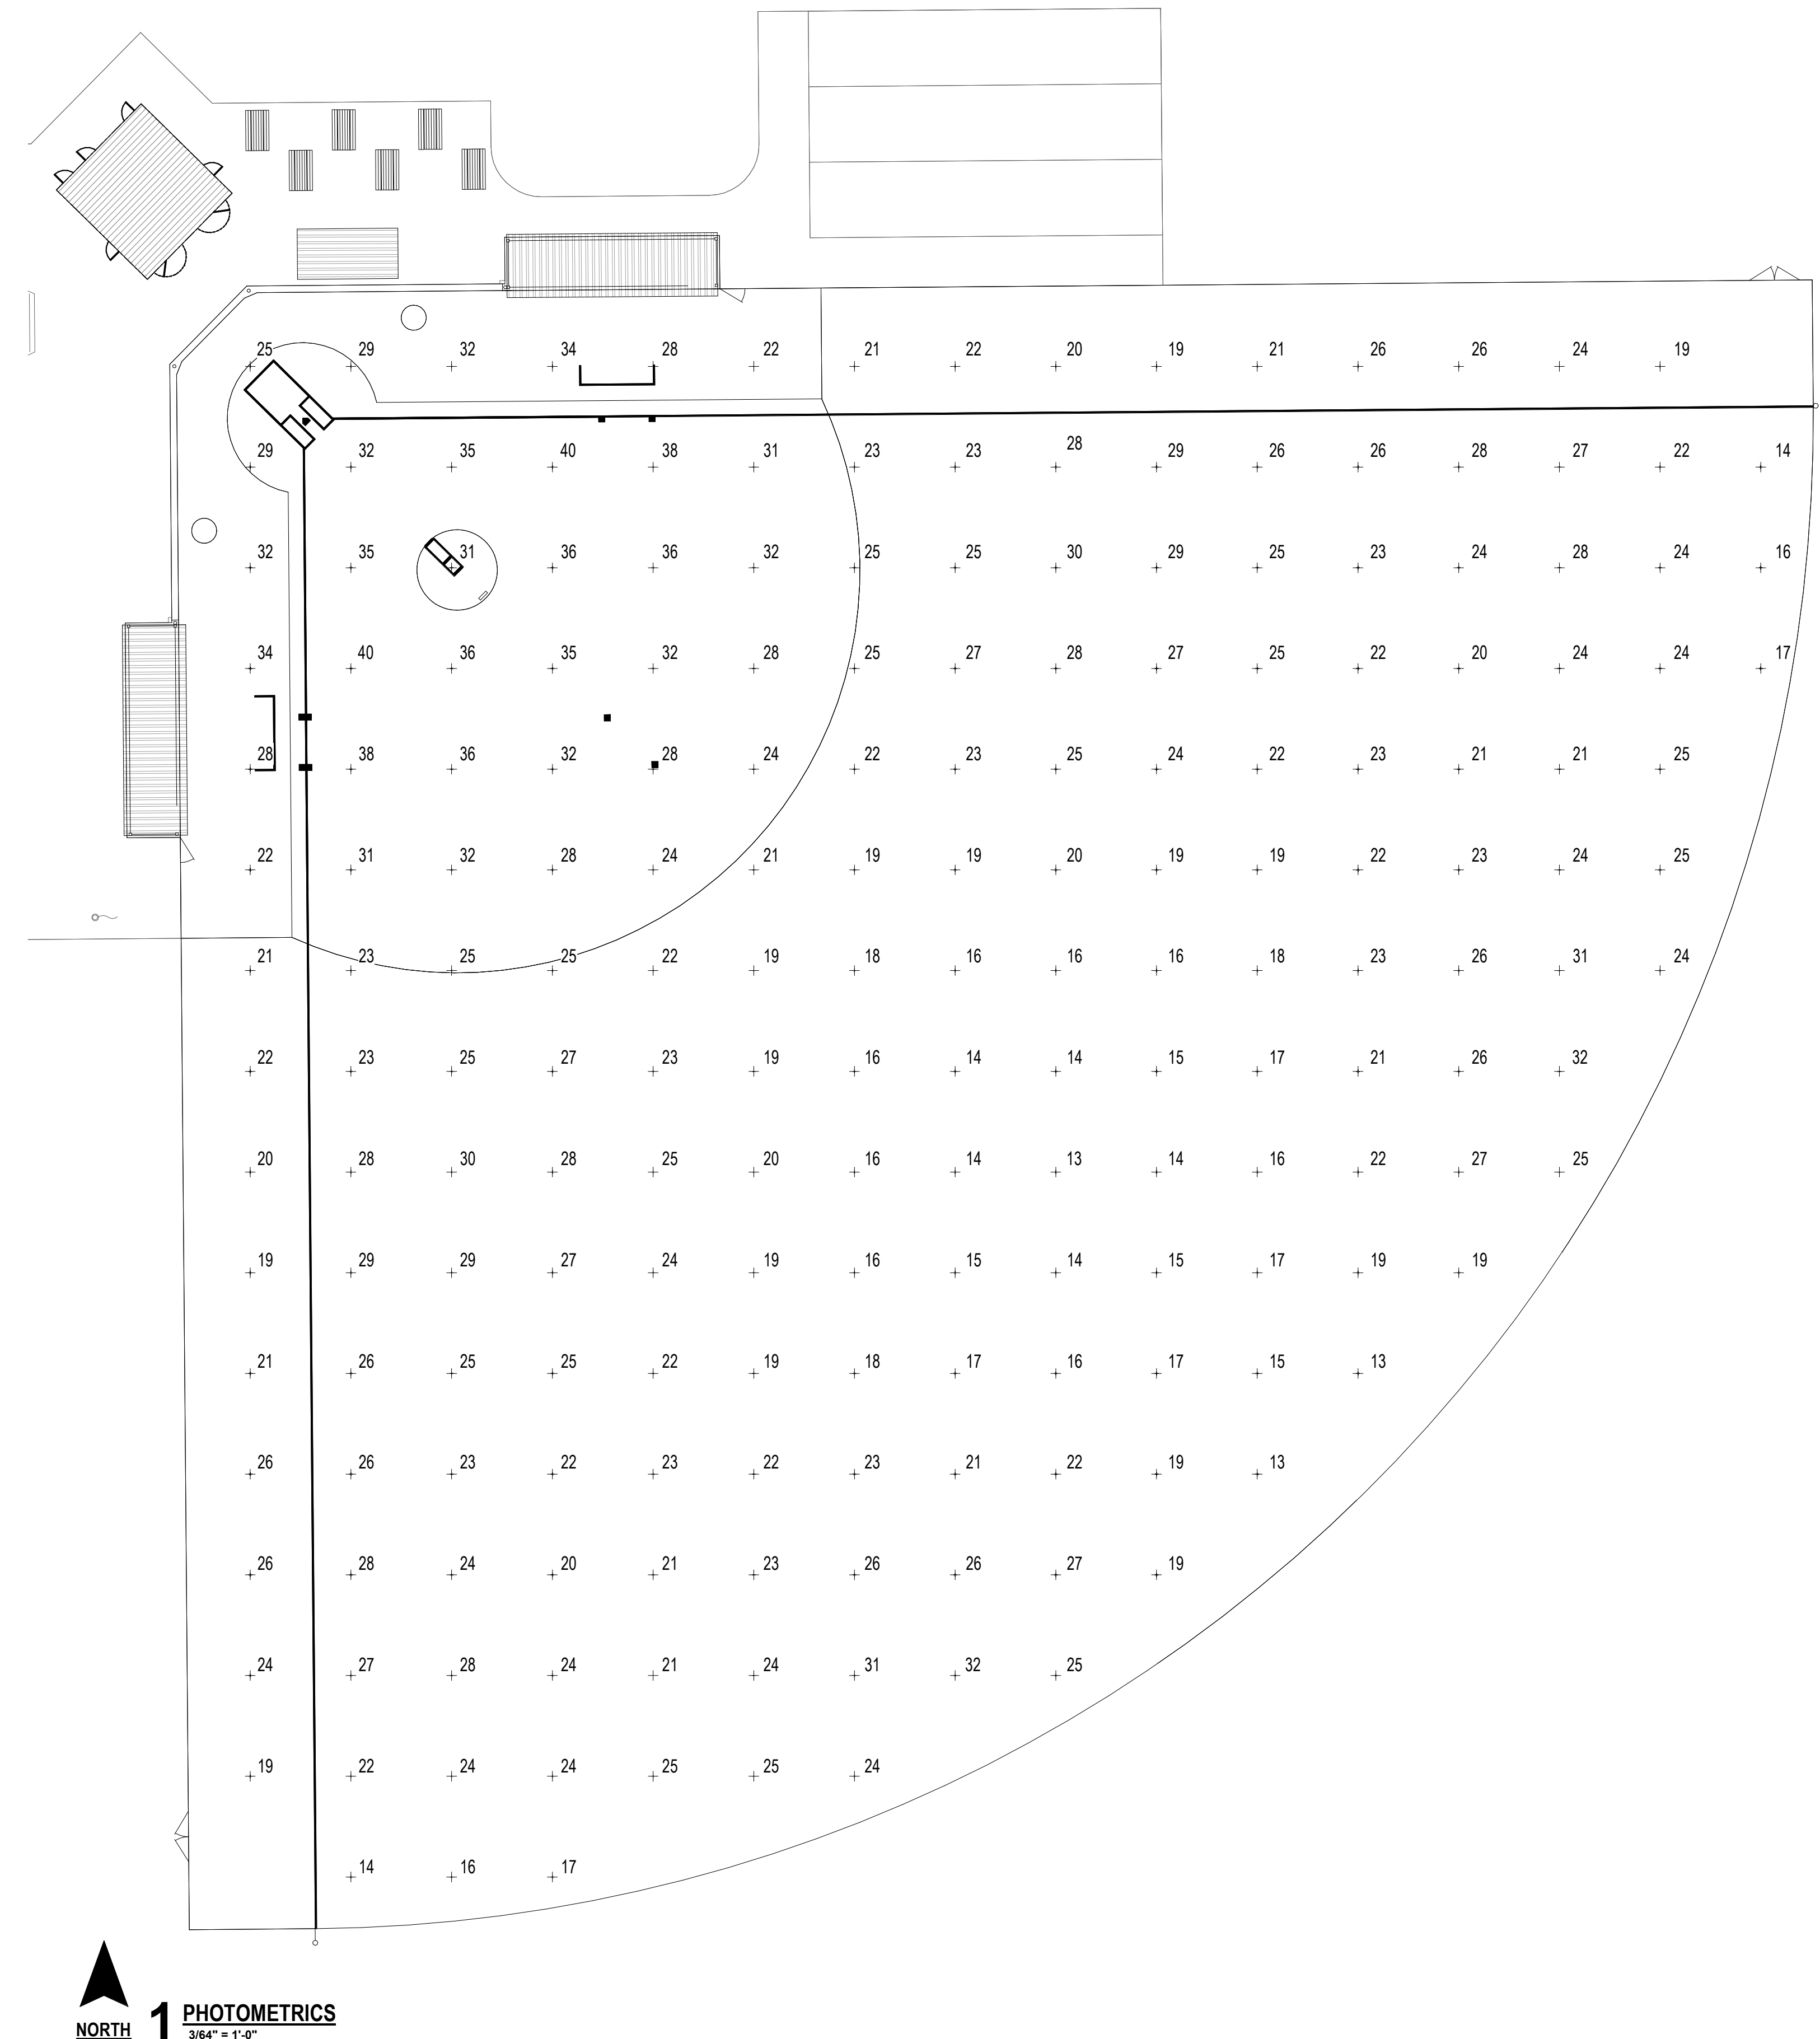

NORTH

1 PHOTOMETRICS
3/64" = 1'-0"

LIGHTING REQUIREMENTS:


INFIELD LIGHTING:
30% AVERAGE
2.51 MAX/MIN

OUTFIELD LIGHTING:
20% AVERAGE
3.01 MAX/MIN


SCHEDULE - FIELD POLE SCHEDULE

NOTES: BELOW IS AN EXAMPLE OF AN APPROVED MANUFACTURER. ALL OTHERS MUST SEEK PRIOR APPROVAL.
FIXTURES SHALL BE CONTROLLABLE FROM CONTROL CABINET LOCATED IN CONCESSION BUILDING
FIXTURES SHALL HAVE 25 YEAR WARRANTY



Mark	DESCRIPTION	POLE HEIGHT	LOAD/POLE	VOLTS	MANUFACTURER	FIXTURE CHARACTERISTICS																	
						FIXTURE ONE			FIXTURE TWO			FIXTURE THREE											
						CATALOG NO.	MOUNTING HEIGHT	QTY/POLE	LUMENS	TEMP.	LOAD	CATALOG NO.	MOUNTING HEIGHT	QTY/POLE	LUMENS	TEMP.	LOAD	CATALOG NO.	MOUNTING HEIGHT	QTY/POLE	LUMENS	TEMP.	LOAD
A1 & A2	FIELD LIGHTING FIXTURES A1 - A2	60' - 0"	2340 VA	240V	MUSCO	TLC-LED-900	60' - 0"	1	104,000	5700K	880 VA	TLC-LED-900	60' - 0"	1	89,600	5700	890	TLC-BT-575	16' - 0"	1	52,000	5700	575
B1 & B2	FIELD LIGHTING FIXTURES B1 - B2	70' - 0"	5250 VA	240V	MUSCO	TLC-LED-1200	70' - 0"	4	150,000	5700	1170 VA	TLC-BT-575	16' - 0"	1	52,000	5700	575	N/A	N/A	N/A	N/A	N/A	N/A
C1 & C2	FIELD LIGHTING FIXTURES C1 - C2	60' - 0"	4670 VA	240V	MUSCO	TLC-LED-900	60' - 0"	4	104,000	5700K	880 VA	TLC-BT-575	16' - 0"	2	52,000	5700	575	N/A	N/A	N/A	N/A	N/A	N/A

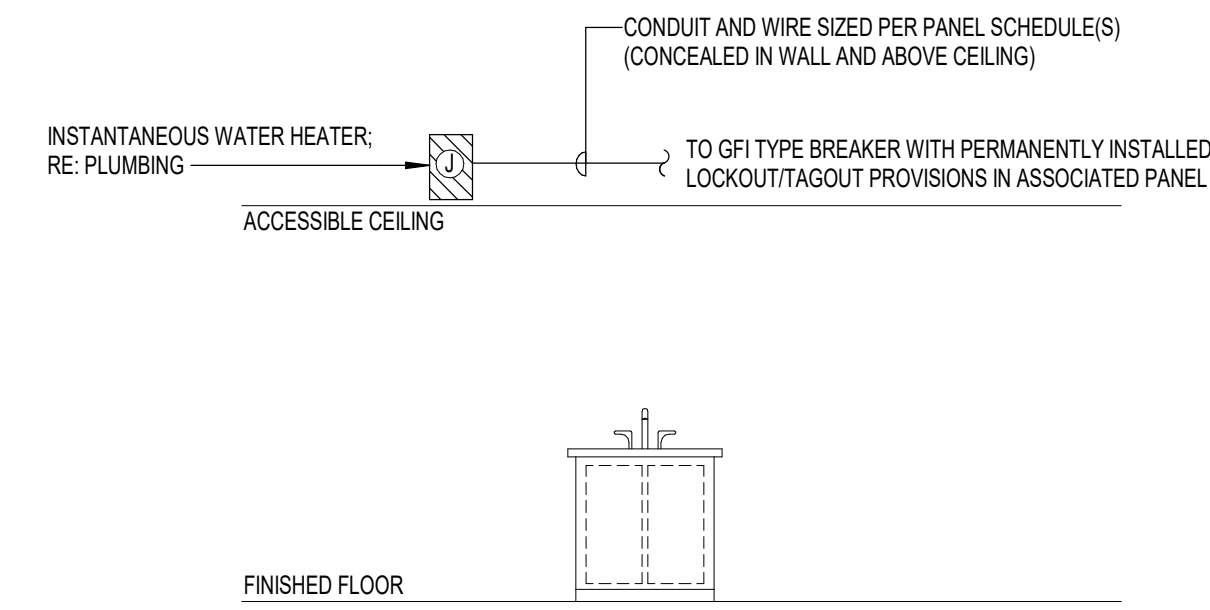

1 DETAIL - ACCESSIBLE INSTANTANEOUS ELECTRIC WATER HEATER
N.T.S.

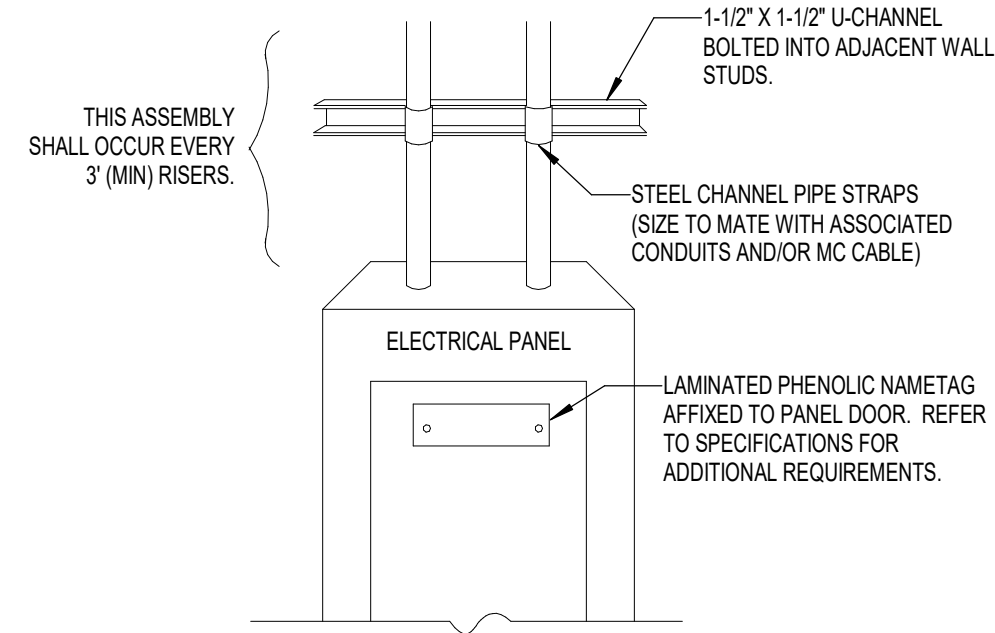


2 DETAIL - CONDUIT SUPPORT
N.T.S.

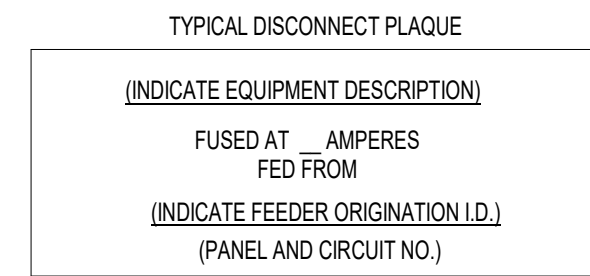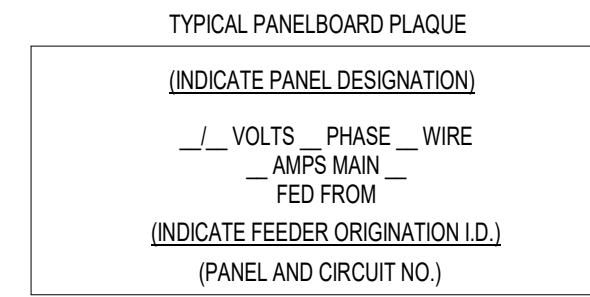


3 DETAIL - EQUIPMENT SIGNAGE
N.T.S.

SEE SPECIFICATIONS FOR MATERIALS, COLORS SIZE LETTERING, ETC.

ATTACH PLAQUES USING INDUSTRIAL GRADE DOUBLE FACE ADHESIVE.

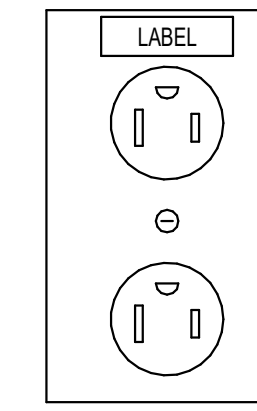


4 DETAIL - RECEPTACLE LABELING
N.T.S.

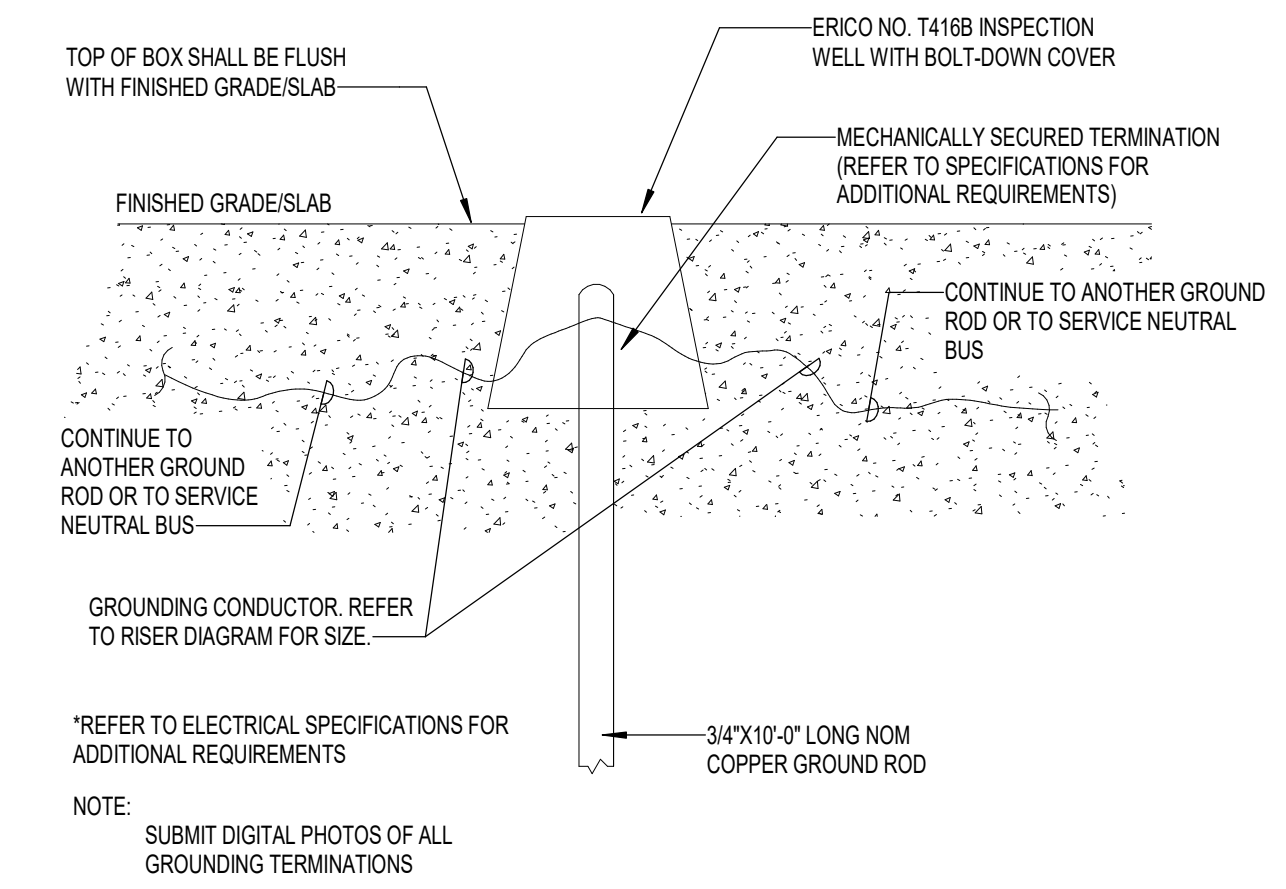


5 DETAIL - GROUND ROD INSTALLATION
N.T.S.

*REFER TO ELECTRICAL SPECIFICATIONS FOR ADDITIONAL REQUIREMENTS

NOTE: SUBMIT DIGITAL PHOTOS OF ALL GROUNDING TERMINATIONS

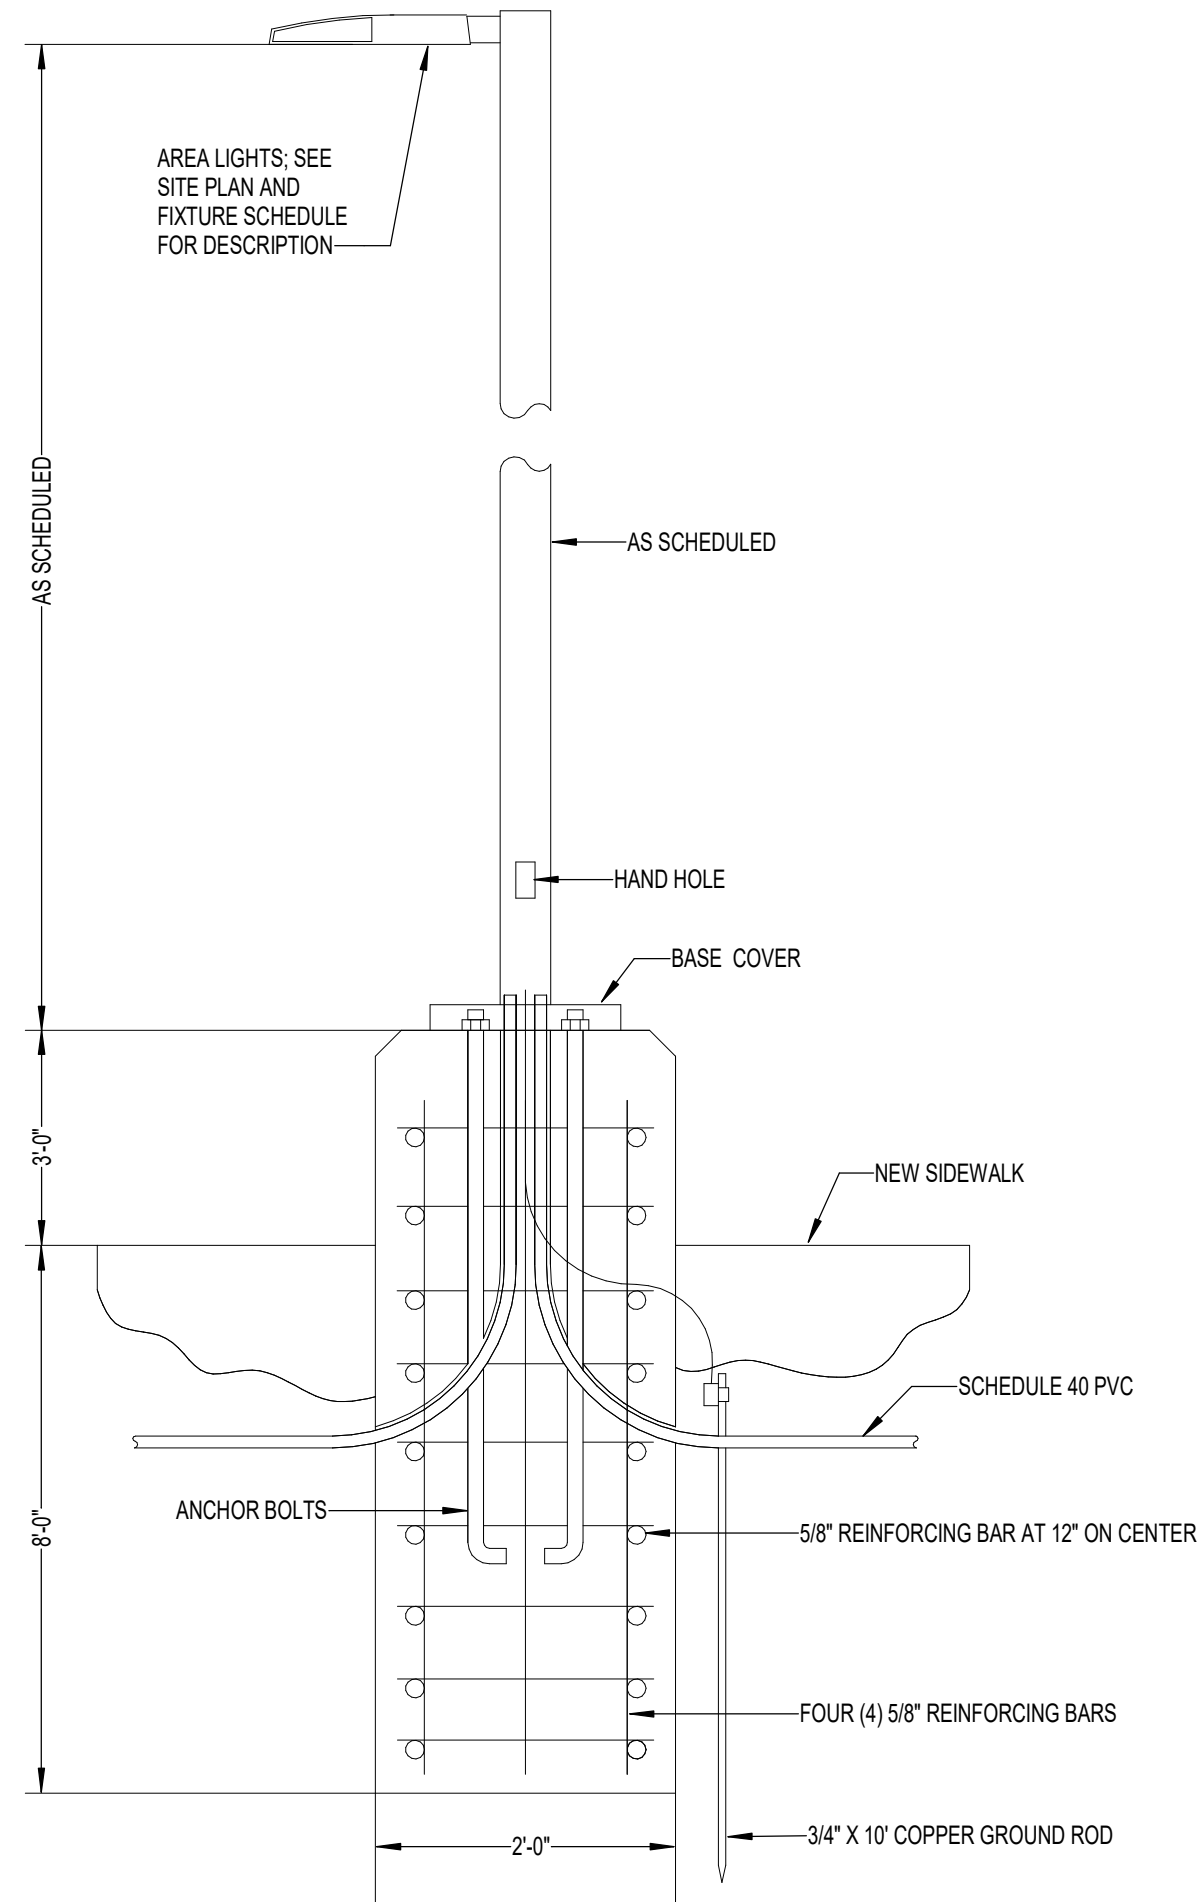


6 DETAIL - PARKING LOT POLE
N.T.S.

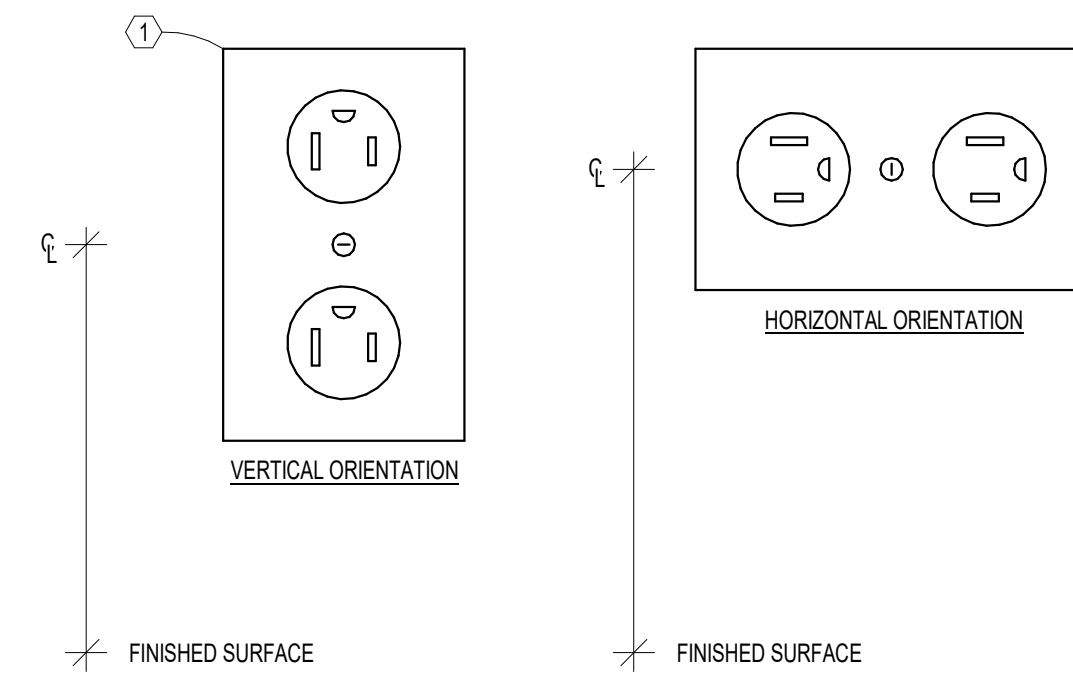

7 DETAIL - RECEPTACLE
N.T.S.


KEYNOTES
 ① REFER TO SPECIFICATIONS FOR RECEPTACLE REQUIREMENTS.
 ② UNLESS DENOTED OTHERWISE ON PLANS, MOUNTING HEIGHT IS FROM FINISHED SURFACE (FLOOR/GRADE/COUNTER TOP/ETC...) TO CENTERLINE OF DEVICE.

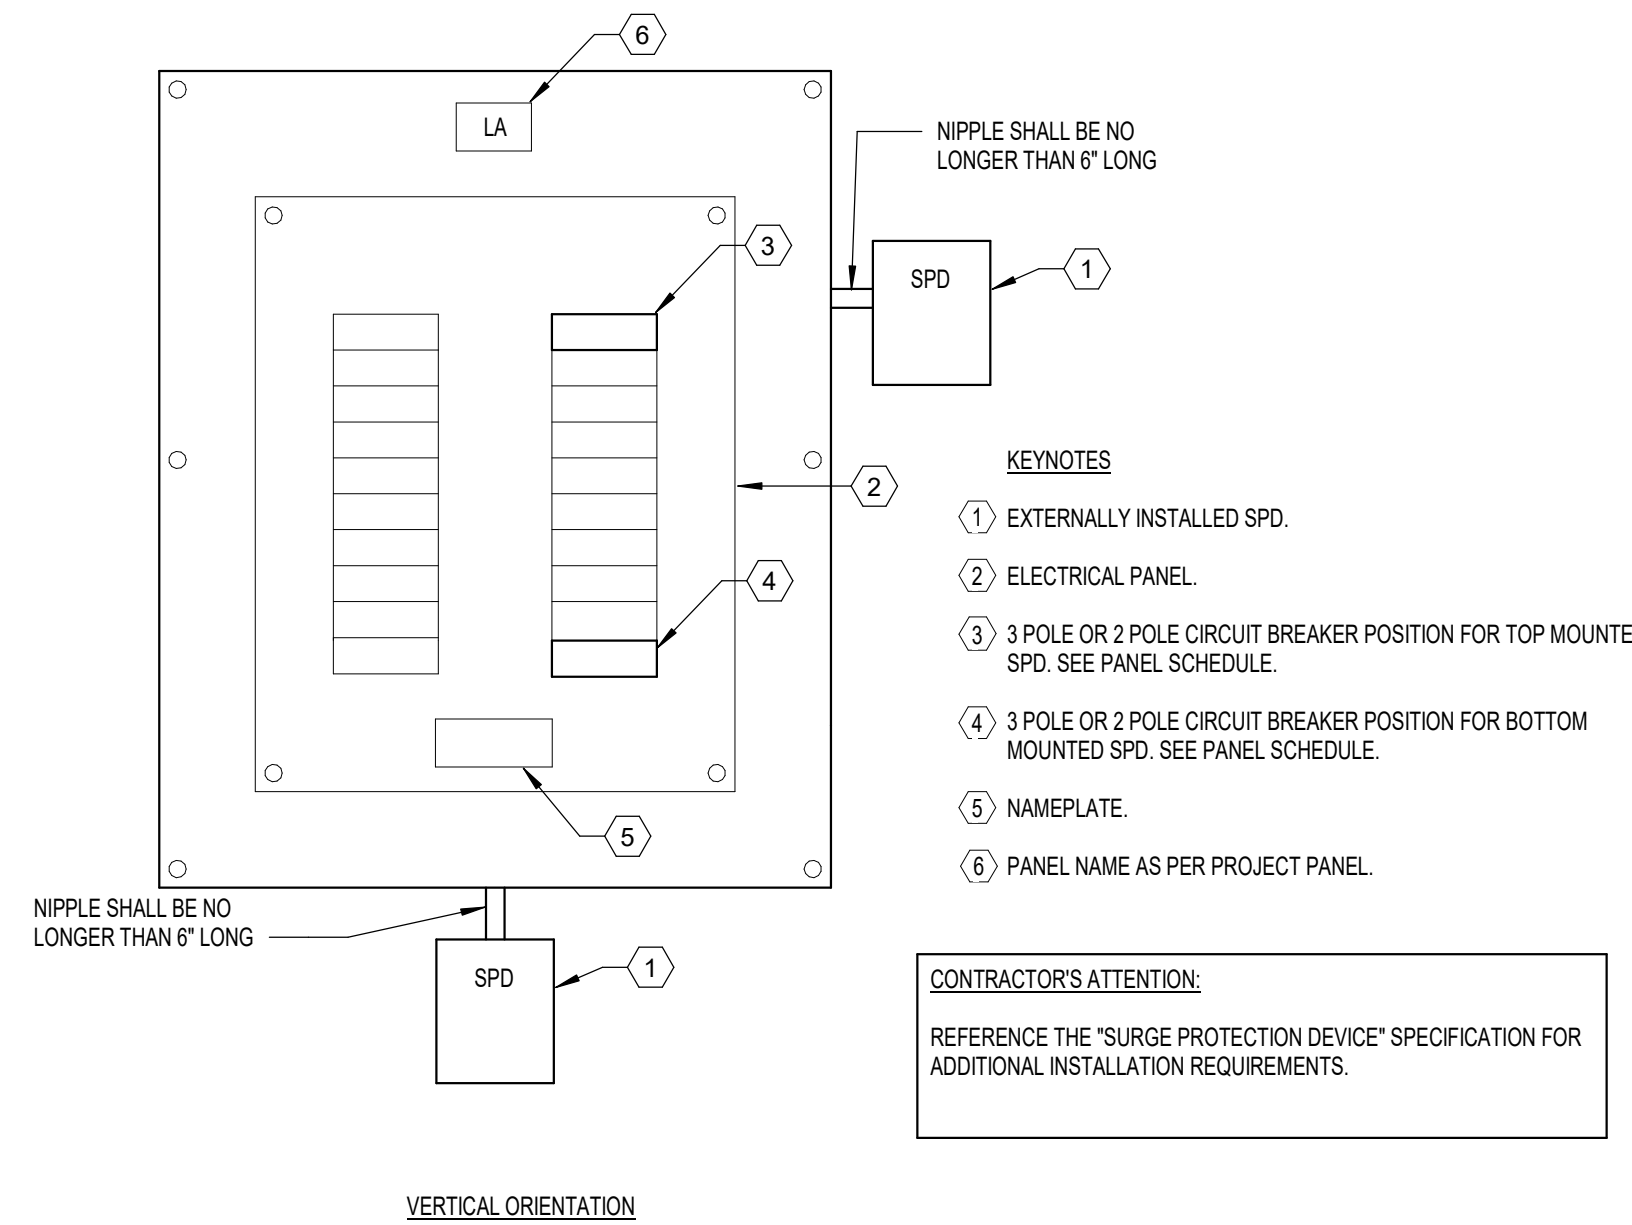

8 DETAIL - EXTERNAL SPD INSTALLATION
N.T.S.

KEYNOTES
 ① EXTERNALLY INSTALLED SPD.
 ② ELECTRICAL PANEL.
 ③ 3 POLE OR 2 POLE CIRCUIT BREAKER POSITION FOR TOP MOUNTED SPD. SEE PANEL SCHEDULE.
 ④ 3 POLE OR 2 POLE CIRCUIT BREAKER POSITION FOR BOTTOM MOUNTED SPD. SEE PANEL SCHEDULE.
 ⑤ NAMEPLATE.
 ⑥ PANEL NAME AS PER PROJECT PANEL.

CONTRACTOR'S ATTENTION:
 REFERENCE THE "SURGE PROTECTION DEVICE" SPECIFICATION FOR ADDITIONAL INSTALLATION REQUIREMENTS.

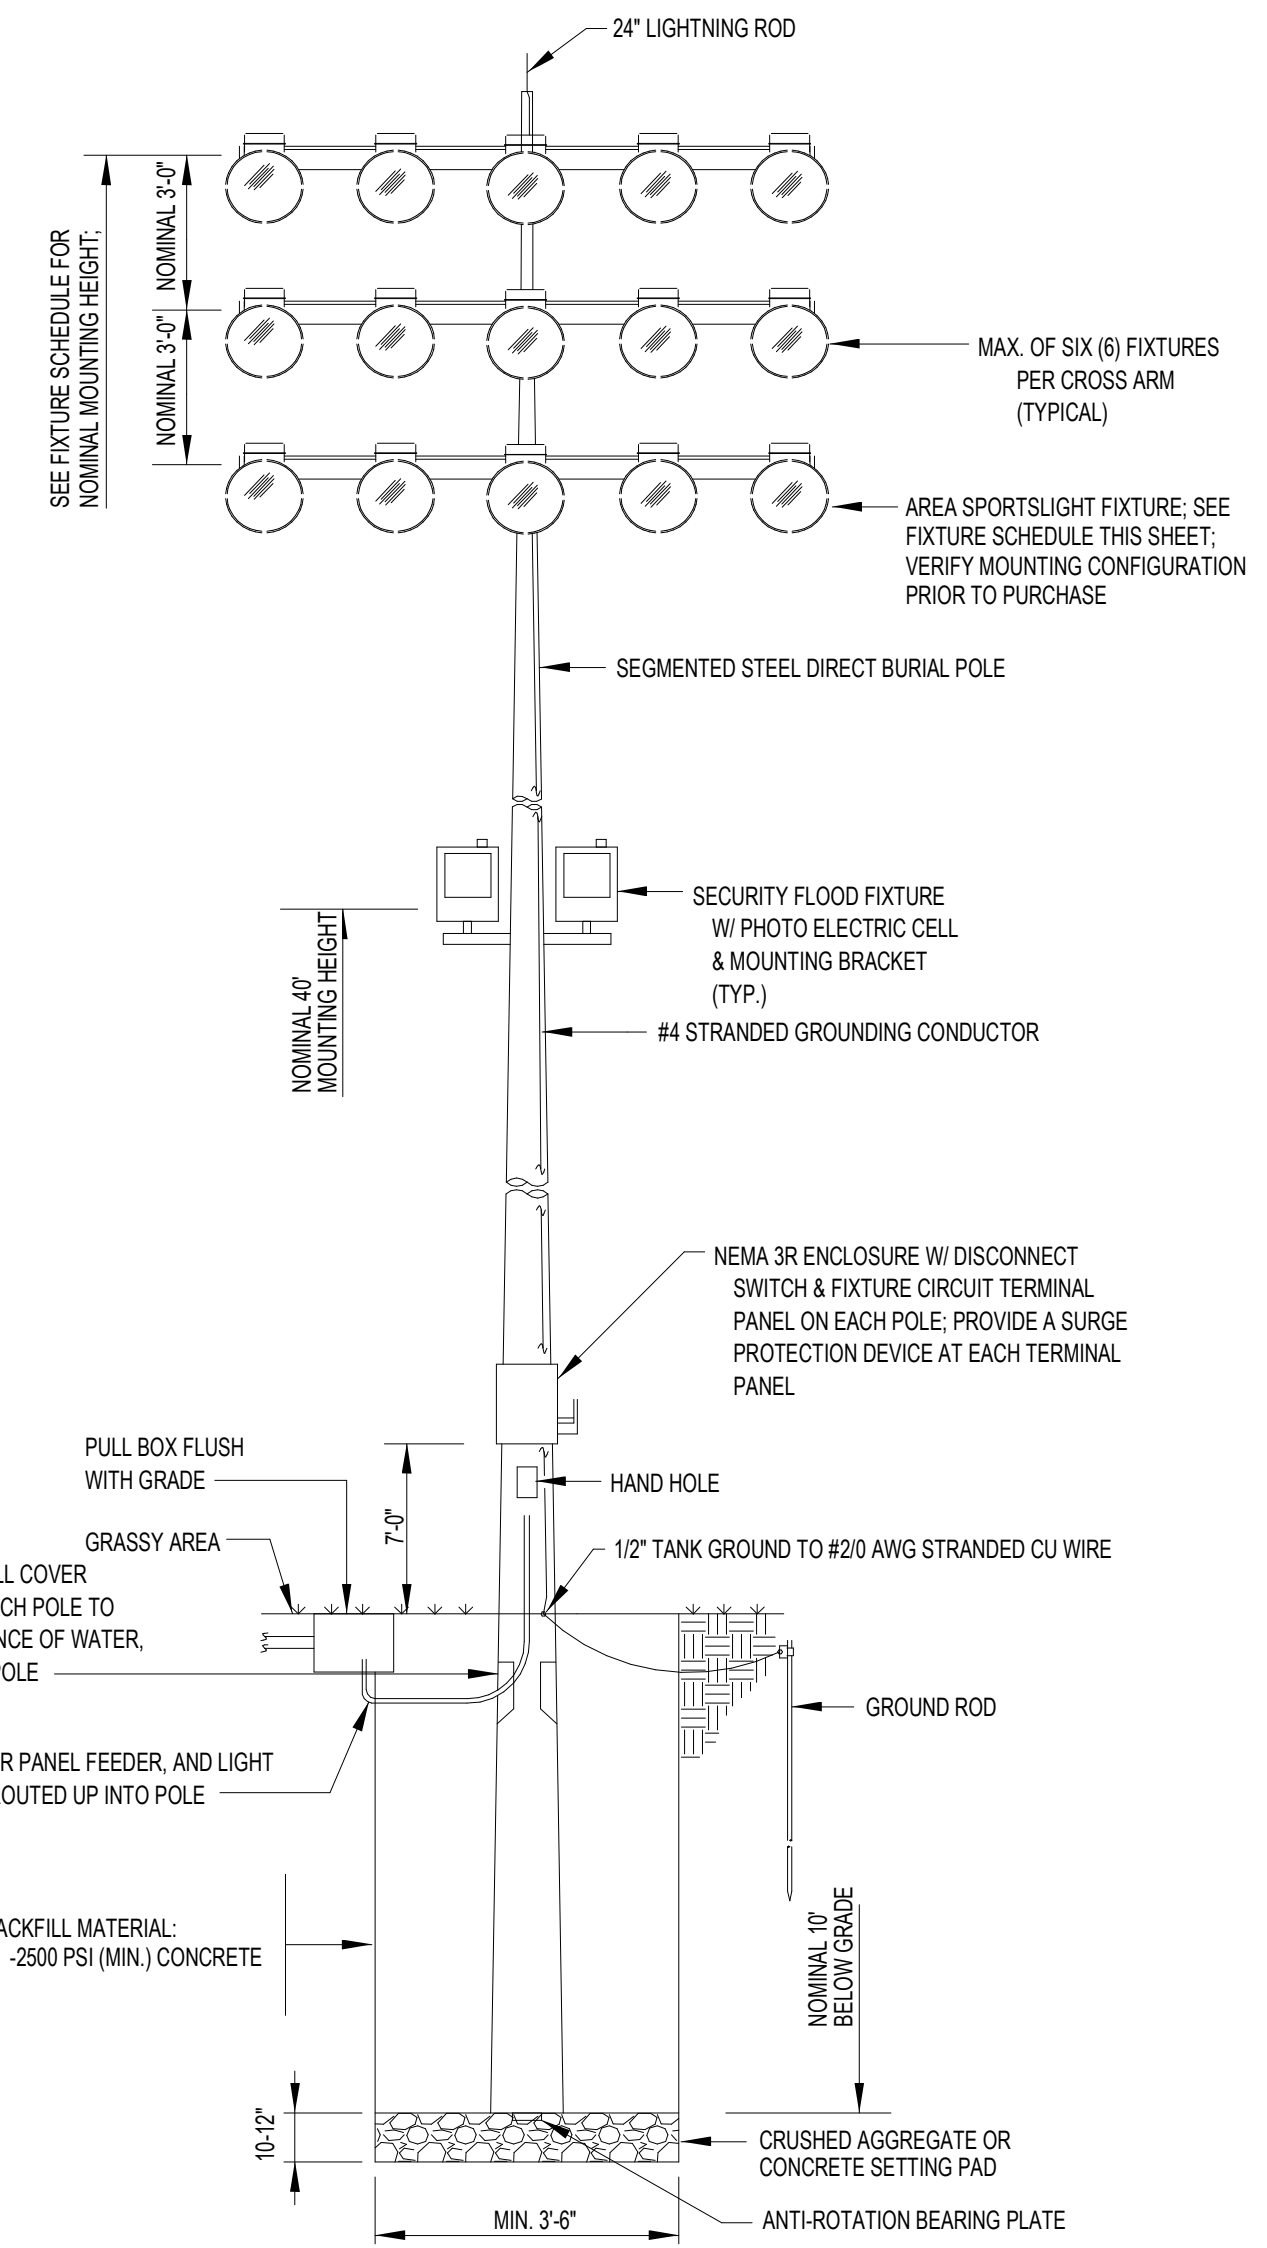


13 DETAIL - SPORTS LIGHTING POLE
N.T.S.


SEE SPECIFICATIONS FOR MATERIALS, COLORS SIZE LETTERING, ETC.

ATTACH PLAQUES USING INDUSTRIAL GRADE DOUBLE FACE ADHESIVE.



NOTE:
 THIS FOUNDATION DETAIL ILLUSTRATES A TYPICAL FOUNDATION AND IS TO BE USED FOR ILLUSTRATION PURPOSES ONLY. THE FOUNDATION SHALL BE DESIGNED BY A LOUISIANA REGISTERED PROFESSIONAL CIVIL ENGINEER PER ELECTRICAL SPECIFICATIONS.

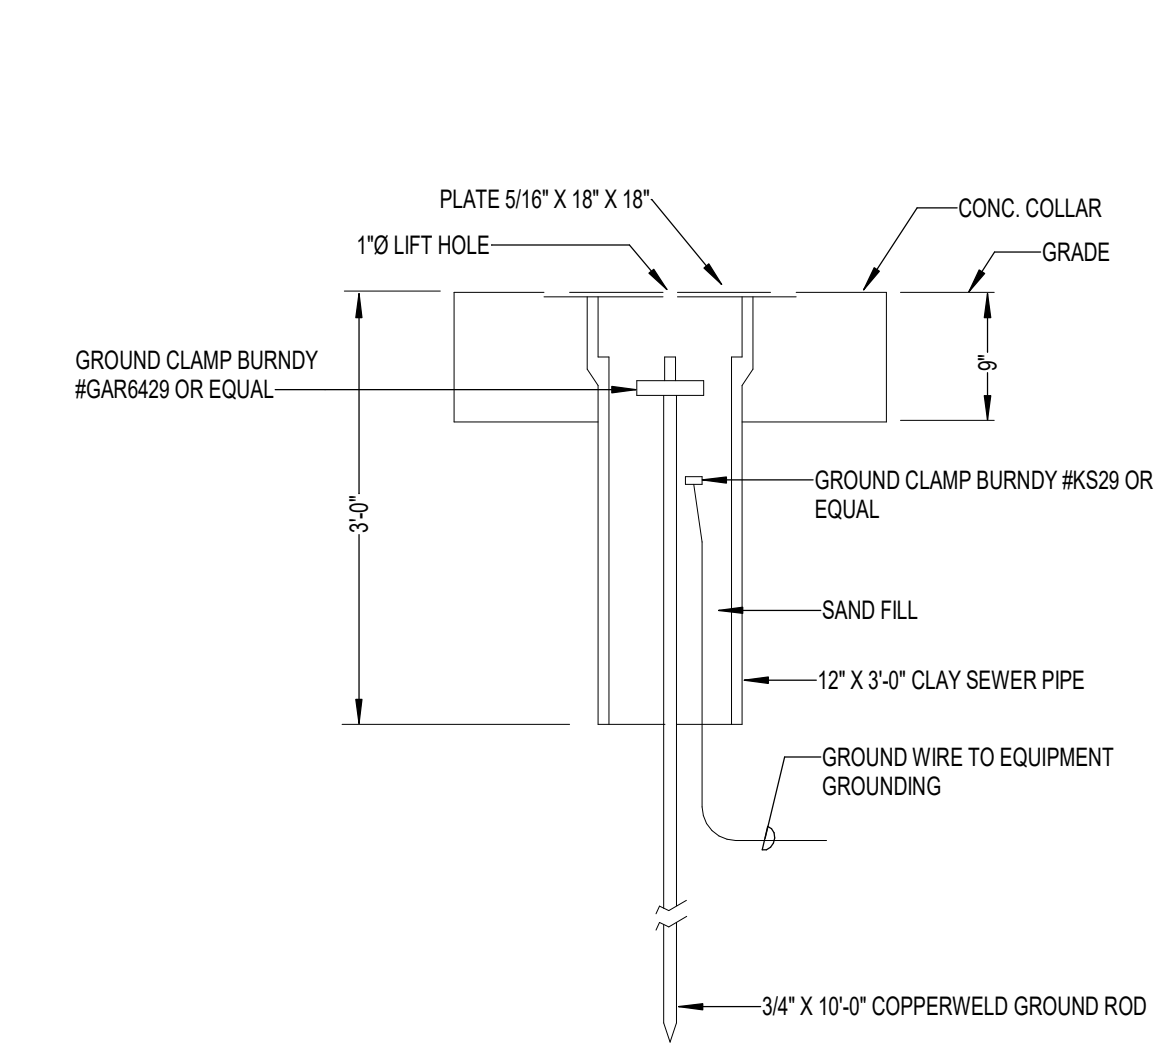

9 DETAIL - GROUNDWELL
N.T.S.

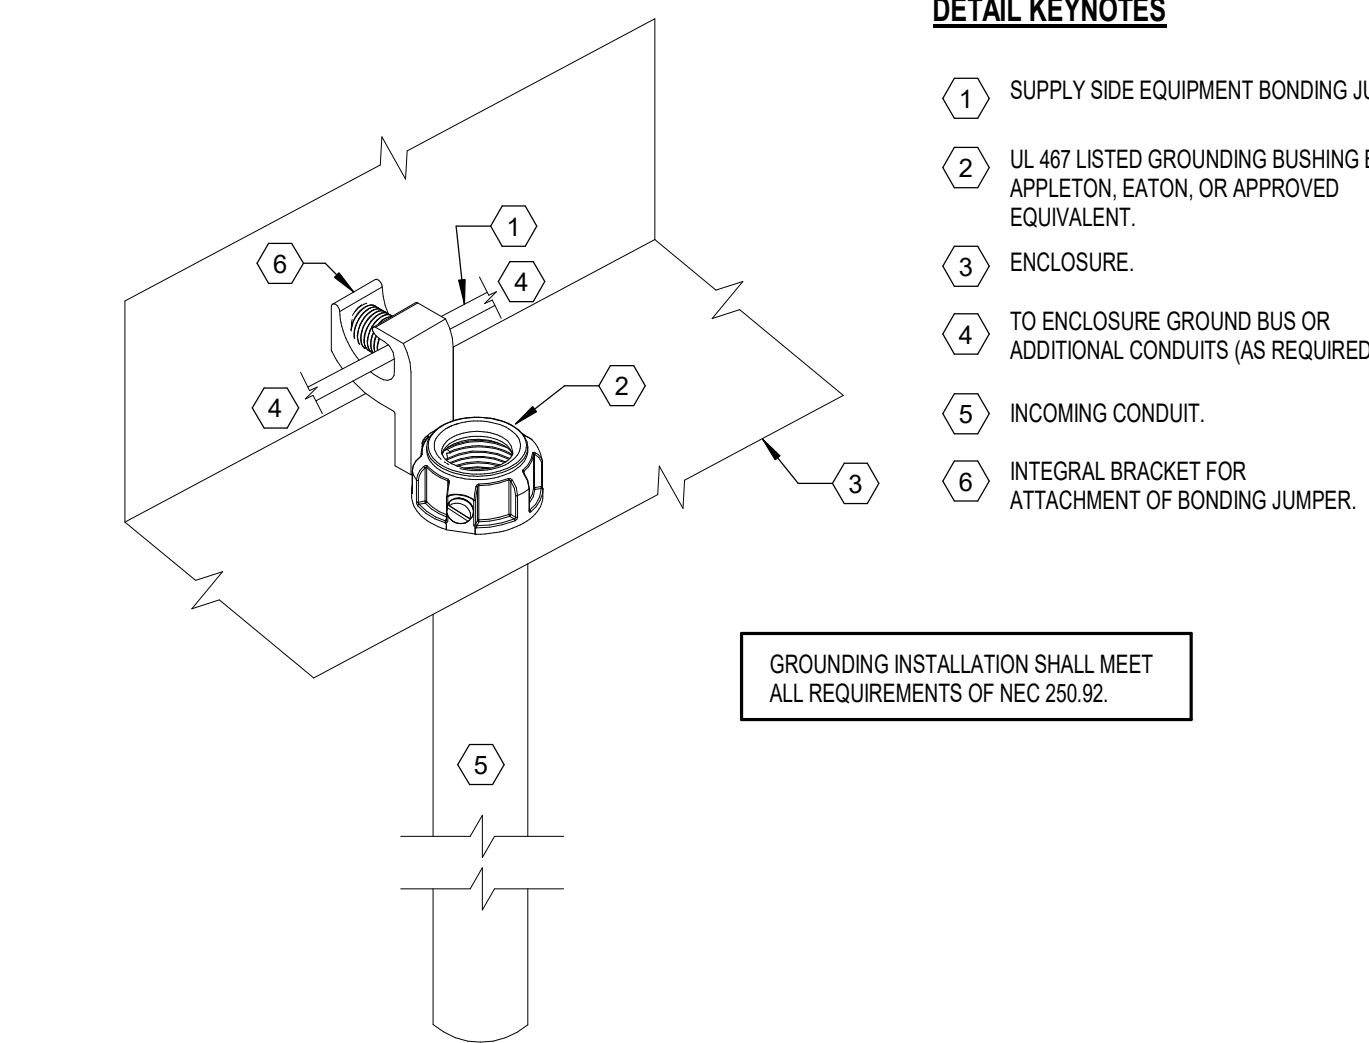

10 DETAIL - CONDUIT GROUND BUSHING
N.T.S.

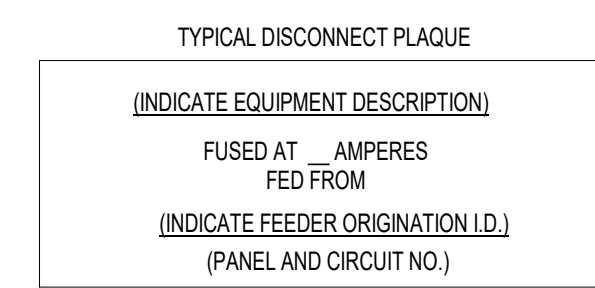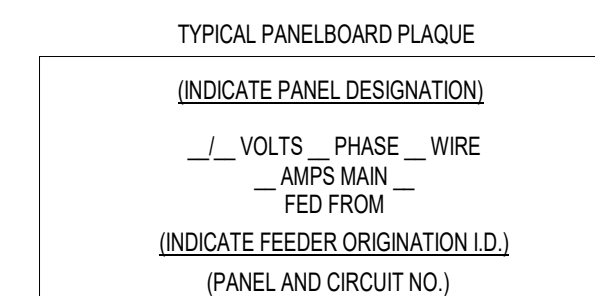

12 DETAIL - EQUIPMENT SIGNAGE
N.T.S.

DETAIL KEYNOTES
 ① SUPPLY SIDE EQUIPMENT BONDING JUMPER.
 ② UL 467 LISTED GROUNDING BUSHING BY APPLETON, EATON, OR APPROVED EQUIVALENT.
 ③ ENCLOSURE.
 ④ TO ENCLOSURE GROUND BUS OR ADDITIONAL CONDUITS (AS REQUIRED).
 ⑤ INCOMING CONDUIT.
 ⑥ INTEGRAL BRACKET FOR ATTACHMENT OF BONDING JUMPER.

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 STATE OF LOUISIANA
 MICHAEL D. BOYD
 ENGINEER
 8/19/2024

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