CONSTRUCTION PLANS

FOR

SOUTHWOOD PARK IMPROVEMENTS

14318 PARKVIEW DRIVE PRAIRIEVILLE, LOUISIANA 70301 OCTOBER 22, 2024

CLIENT



PARISH OF ASCENSION GOVERNMENT

CLINT COINTMENT

PARISH PRESIDENT

COUNCIL MEMBERS

OLIVER JOSEPH, DISTRICT 1 JOEL ROBERT. DISTRICT 2 TRAVIS TURNER, DISTRICT 3 BRETT ARCENEAUX, DISTRICT 4 TODD VARNADO, DISTRICT 5 CHASE MELANCON, DISTRICT 6


BRIAN HILLENSBECK, DISTRICT 7 BLAINE PETITE, DISTRICT 8 PAM ALONSO, DISTRICT 9 **DENNIS CULLEN, DISTRICT 10** MICHAEL MASON, DISTRICT 11

PARISH STAFF

BRANDON SMITH, CPRP RANDY MULLIS

DIRECTOR OF RECREATION PROJECT MANAGER

Sheet Number G-0.0	INDEX OF DRAWINGS Sheet Title
G-0.0	
	COVER SHEET
G-0.1	GENERAL PROJECT NOTES
L-0.0	EXISTING CONDITIONS AND DEMOLITION PLAN
L-1.0	OVERALL SITE PLAN
L-1.1	ENLARGED LAYOUT PLAN
L-2.0	GRADING PLAN
L-3.0	UTILITY PLAN
L-4.0	EROSION CONTROL AND SEDIMENTATION PLAN
L-5.0	LANDSCAPE PLANTING PLAN
L-6.0	PRE-ENGINEERED RESTROOM BUILDING AND ELEVATIONS
L-7.0	SITE IMPROVEMENT DETAILS
L-7.1	SITE IMPROVEMENT DETAILS
E0.0	ELECTRICAL COVER SHEET
E1.0	ELECTRICAL SITE PLAN
E2.0	RESTROOM BUILDING ELECTRICAL PLAN
E3.0	RISER DIAGRAM & SCHEDULES
E4.0	ELECTRICAL DETAILS

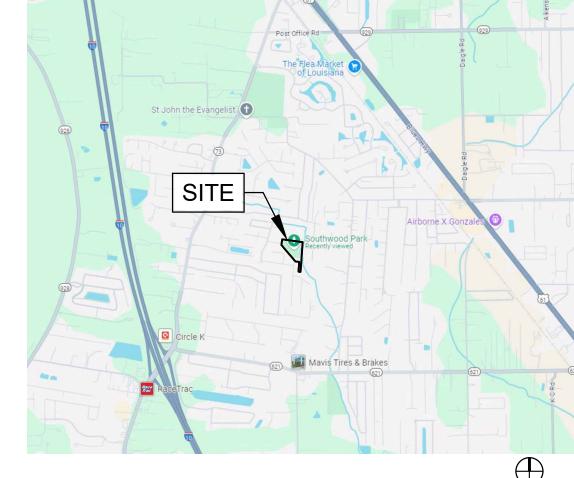

VICINITY MAP

DESIGN TEAM

LANDSCAPE ARCHITECT DUPLANTIS DESIGN GROUP, PC 9015 BLUEBONNET BLVD. BATON ROUGE, LA. 70810 PHONE - 225-751-4490 MICHAEL L. PETTY, PLA (mpetty@ddgpc.com)

> **ELECTRICAL ENGINEER** PARISH ENGINEERING, LLC 7600 INNOVATION PARK DR. BATON ROUGE, LA 70820 PHONE - 225-332-02222 MICHAEL L. TERRY, III, P.E.



AREA MAP

REGIONAL NOTIFICATION CENTER BY TELEPHONE 48 HOURS IN ADVANCE OF ANY EXCAVATION OR DEMOLITION ACTIVITY. THE OWNERS/OPERATORS OF ANY UNDERGROUND FACILITY MUST THEN MARK

COVER SHEET

ARK IMPROVEMENTS

BID SET -**NOT FOR** CONSTRUCTION PROJECT NO. ISSUED FOR BID 10/22/2024

G-0.0

SHEET

CHECKED DRAWN BY

THE PROPOSED PROJECT INCLUDES THE MODIFICATION AND EXPANSION OF THE PARK FACILITIES INCLUDING NEW PICKLEBALL COURTS, A PRE-ENGINEERED RESTROOM BUILDING, SIDEWALKS, DRAINAGE, AND OTHER ASSOCIATED SITE IMPROVEMENTS.

THE CONTRACTOR SHALL BE RESPONSIBLE FOR THE CONSTRUCTION OF THE PROJECT IN ACCORDANCE WITH THESE CONTRACT DOCUMENTS. THE CONTRACTOR SHALL ALSO BE RESPONSIBLE FOR SECURING ALL REQUIRED PERMITS FROM ANY GOVERNING BODIES AND AGENCIES NEEDED FOR

THE PROJECT SITE INCLUDES SEVERAL EXISTING UTILITIES, OVERHEAD AND UNDERGROUND, WHICH WILL REQUIRE ATTENTION DURING THE WORK. ALL UTILITIES WILL REQUIRE LOCATION BY THE CONTRACTOR PRIOR TO BEGINNING CONSTRUCTION. CONTRACTOR MUST CONTACT LOUISIANA ONE CALL (1-800-272-3020) A MINIMUM OF 48 HOURS PRIOR TO CONSTRUCTION TO HAVE UTILITIES FIELD LOCATED. IF ANY UNFORESEEN UTILITY LINE, FTC.. IS OBSTRUCTING SCOPE OF WORK, NOTIFY LANDSCAPE ARCHITECT IMMEDIATELY.

THE UTILITIES INDICATED ON THE DRAWINGS WILL REQUIRE ACCURATE LOCATION BY THE CONTRACTOR PRIOR TO BEGINNING WORK. CLOSE MONITORING OF EXCAVATION AND EMBANKMENT ACTIVITIES AROUND THESE UTILITIES WILL ALSO BE REQUIRED BY THE CONTRACTOR DURING

THE CONTRACTOR SHALL MAINTAIN PROPER CLEARANCES FROM ALL OVERHEAD AND UNDERGROUND UTILITIES, AND SHALL CONTACT EACH UTILITY FOR SPECIFIC REQUIREMENTS.

PRIOR TO ALL CONSTRUCTION, THE CONTRACTOR IS RESPONSIBLE FOR MAKING HIS/HER OWN DETERMINATIONS AS TO THE TYPE AND LOCATION OF UNDERGROUND UTILITIES AS MAY BE NECESSARY TO AVOID DAMAGE THERETO. SHOULD A GRADE DIFFERENCE, UTILITY CONFLICT OR OBSTRUCTION TO CONSTRUCTION OCCUR, THE CONTRACTOR SHALL NOTIFY LANDSCAPE ARCHITECT PRIOR TO COMMENCING WORK IN THAT AREA.

CONTRACTOR SHALL BE RESPONSIBLE FOR REPAIRING AND/OR REPLACING ANY DAMAGED UTILITIES AT NO ADDITIONAL COST TO THE OWNER.

THE UTILITY CONTACTS ARE AS FOLLOWS:

ELECTRIC: ENTERGY 1619 S. BURNSIDE AVE PHONE: AT&T (800) 288-2747

GONZALES, LA (800) 968-8243

ATMOS ENERGY 40492 ABBY JAMES RD PRAIRIEVILLE, LA

(225) 622-2167

WATER: ASCENSION WATER COMPANY 14169 AIRLINE HWY. GONZALES, LA (225) 675-5644

SEWER: PRIVATE TREATMENT PLANT

PROJECT CONTROL

ALL SPECIFIED CONTROL MEASURES WILL BE MAINTAINED IN EFFECTIVE CONDITION THROUGHOUT THE CONSTRUCTION PERIOD.

ANY DISCREPANCIES BETWEEN ACTUAL SITE CONDITIONS AND THE CONSTRUCTION DOCUMENTS SHALL BE BROUGHT TO THE ATTENTION OF THE LANDSCAPE ARCHITECT IN A TIMELY MANNER TO NOT ADVERSELY AFFECT PROGRESS OF WORK.

STAGING FOR MATERIALS AND EQUIPMENT SHALL BE COORDINATED WITH OWNER. CONTRACTOR SHALL BE REQUIRED TO KEEP STREETS FREE OF

EQUIPMENT SHALL NOT BE ORDERED OR INSTALLED UNTIL IT IS APPROVED BY LANDSCAPE ARCHITECT. EQUIPMENT LOCATIONS MAY BE ADJUSTED ONLY WITH PERMISSION OF LANDSCAPE ARCHITECT. THE CONTRACTOR SHALL FURNISH AS-BUILT DRAWINGS WHICH SHOW THE FINAL INSTALLED LOCATIONS OF ALL EQUIPMENT AND UNDERGROUND PIPES/CONDUITS.

ALL CONSTRUCTION TO COMPLY WITH ALL APPLICABLE CODES AND ORDINANCES.

CONTRACTOR SHALL BE FAMILIAR WITH ACTUAL SITE CONDITIONS BEFORE PROCEEDING WITH WORK

CONTRACTOR IS RESPONSIBLE FOR THE REMOVAL OF ALL CONSTRUCTION AND DEMOLITION DEBRIS FROM SITE IN ACCORDANCE WITH ALL APPLICABLE STATE, FEDERAL AND LOCAL REGULATIONS. NO CONSTRUCTION DEBRIS IS TO BE BURIED OR DEPOSITED ON SITE.

LAYOUT, GEOMETRY & DIMENSIONS OF ALL PROPOSED PAVING MAY REQUIRE ADJUSTMENTS IN THE FIELD. FINAL STAKING OF ALL PROPOSED WALKS AND PAVING AREAS MUST BE APPROVED BY LANDSCAPE ARCHITECT PRIOR TO PLACING CONCRETE PAVING MATERIAL. LAYOUT OF FORMWORK SHOULD BE DONE IN A MANNER THAT RESULTS IN SMOOTH TANGENTS AND RADII AS INDICATED ON THE LAYOUT PLAN. ERRATIC

CONTRACTOR IS RESPONSIBLE FOR REPAIRING ALL EXISTING GRADES DAMAGED DURING CONSTRUCTION, IN ORDER TO PROVIDE POSITIVE DRAINAGE.

PROJECT SEQUENCE: THESE DOCUMENTS DO NOT DESCRIBE THE MEANS, METHODS AND PROCEDURES FOR ACCOMPLISHING THE WORK. THE CONTRACTOR IS RESPONSIBLE FOR SETTING THESE GUIDELINES TO SUCCESSFULLY COMPLETE THE PROJECT IN THE TIME PROVIDED. BASIC ELEMENTS OF THE PROJECT INVOLVE SEQUENCING IN ORDER FOR THE CONSTRUCTION TO PROCEED IN AN ORDERLY MANNER.

EROSION AND SEDIMENT CONTROL MEASURES WILL BE INSTALLED PRIOR TO CONSTRUCTION AS INDICATED ON PLANS. CONTRACTOR SHALL PROVIDE SILT FENCING AS DIRECTED BY THE LANDSCAPE ARCHITECT TO PREVENT ANY SEDIMENT OR POLLUTION FROM WASHING INTO EXISTING CATCH BASINS, CURB INLETS AND DRAINAGE CANALS WITHIN THE AREAS OF THE PROJECT THAT WILL RECEIVE EARTH MOVING AND GRADING OPERATIONS. SILT FENCING SHALL BE PROVIDED AND INSTALLED AS PER PLANS AND SPECIFICATIONS.

EARTHWORK - EXCAVATION AND EMBANKMENT FOR FIELD, OPEN SPACES, AND DRAINAGE AS SHOWN ON THE PLANS AND SECTIONS.

BACKFILL AGAINST NEW SIDEWALK EDGES, TYPICALLY HOLDING BACKFILL APPROXIMATELY 1 1/2" TO 2" BELOW TOP OF SIDEWALK (IN AREAS TO RECEIVE SOD) AS TO AVOID HOLDING WATER ON PAVEMENT. FILL SHOULD BE GRADED TO ELIMINATE LARGE CLODS OF DIRT.

ALL MIXING, TRANSPORTING, PLACING AND CURING OF CONCRETE SHALL BE DONE IN ACCORDANCE WITH THE SPECIFICATIONS.

ALL SIDEWALKS SHALL BE A MINIMUM OF 4" THICK, 3500 PSI, REINFORCED WITH 6"x6" W 2.1 W.W.F. - CONCRETE SHALL BE LIGHTLY BROOM FINISHED PERPENDICULAR TO DIRECTION OF WALK.

ALL SIDEWALKS SHALL MAINTAIN A MINIMUM OF 1:100 AND MAXIMUM OF 1:50 CROSS SLOPE. ALL SIDEWALK CROSS SLOPES MUST SLOPE TOWARDS EXISTING AND OR NEW CATCH BASINS AND OR TOWARDS THE SIDE THAT IS NEARER A LOWER CONTOUR. SIDEWALKS CROSS SLOPED INTO CONTOUR'S ON THE HIGH SIDE CAUSING WATER TO BE TRAPPED WILL NOT BE ACCEPTED.

CONTRACTOR SHALL MAKE SMOOTH, FLUSH TRANSITION BETWEEN ALL EXISTING AND PROPOSED PAVEMENTS.

CONTRACTOR SHALL PROVIDE EXPANSION JOINTS AT MAXIMUM 60' INTERVALS OR FOR 350 SQ. FT. MAXIMUM AREAS. EXPANSION JOINT SHALL ALSO BE PLACED BETWEEN INTERSECTING PAVING AND ANY FIXED STRUCTURE SUCH AS BUILDINGS AND CURBING. EXPANSION JOINTS TO BE FILLED WITH 1/2" THICK PRE-FORMED EXPANSION MATERIAL AND EXTEND THE FULL WIDTH AND DEPTH OF THE PAVING WITH THE TOP 3/4" RECESSED BELOW FINISH GRADE. TOP 3/4" OF JOINT TO BE SEALED WITH AN APPROVED JOINT ELASTOMERIC SEALANT.

PROVIDE 1" DIAMETER SMOOTH PLASTIC-COATED STEEL DOWELS @ 12" O.C. AT ALL SIDEWALK EXPANSION JOINT LOCATIONS. DOWEL BARS SHALL BE SLEEVED ON ONE SIDE. DOWELS SHALL BE SPACED SO THAT IT IS NOT MORE THAN 6" FROM THE EDGE OF CONCRETE.

CONTRACTOR SHALL PROVIDE WEAKENED PLANE JOINTS BY A JOINTING TOOL OR OTHER ACCEPTABLE MEANS. THE JOINT SHALL EXTEND INTO CONCRETE A LEAST 1/4 OF THE PAVEMENT DEPTH.

CONTRACTOR IS RESPONSIBLE FOR SECURITY OF FRESHLY POURED CONCRETE UNTIL CONCRETE HARDENS. PROTECT CONCRETE FROM VANDALISM AND ADVERSE WEATHER CONDITIONS.

SHOP DRAWINGS FOR ALL REQUIRED ITEMS SHALL BE PROVIDED BY THE CONTRACTOR FOR APPROVAL, IN DETAIL SUFFICIENT TO FABRICATE & INSTALL ALL MEMBERS & PIECES NECESSARY FOR COMPLETION. NO WORK OR INSTALLATION SHALL BE STARTED ON ANY OF THESE ITEMS UNTIL FINAL APPROVAL OF SHOP DRAWINGS HAS BEEN OBTAINED FROM LANDSCAPE ARCHITECT. REVIEW & APPROVAL OF THESE DRAWINGS & OTHER REQUIRED SUBMITTALS WILL NOT RELIEVE THE CONTRACTOR OF RESPONSIBILITY UNDER THIS CONTRACT.

ALL SLOPE SIDES OF EXCAVATIONS AND/OR TRENCHES FOR INSTALLING CONDUIT SHALL COMPLY WITH OSHA REGULATIONS AND ANY APPLICABLE LOCAL CODES AND ORDINANCES. SHORE AND BRACE WHERE SLOPING IS NOT POSSIBLE BECAUSE OF SPACE RESTRICTIONS OR STABILITY OF MATERIAL EXCAVATED. MAINTAIN SIDES AND SLOPES OF EXCAVATIONS IN A SAFE CONDITION UNTIL COMPLETION OF BACKFILLING.

UNDERGROUND CONDUITS SHALL BE HAND PLACED INSIDE THE TRENCH, AND THE TRENCH BACKFILLED THE SAME DAY TO THE SATISFACTION OF THE LANDSCAPE ARCHITECT. TRENCH SHALL BE PACKED IN 6" LIFTS TO ENSURE COMPACTION & REDUCE SETTLING.

WHEREVER LAWN IS DISTURBED. KILLED OR LEFT IN AN UNHEALTHY CONDITION AS DETERMINED BY THE LANDSCAPE ARCHITECT. IT IS TO BE RE-SODDED BY THE CONTRACTOR WITH CENTIPEDE SOD AS DIRECTED BY LANDSCAPE ARCHITECT. REFER TO THE SPECIFICATIONS FOR INSTALLATION

NOTED ON PLANS. REFER TO LAYOUT SHEETS FOR LIMITS OF PROPOSED PAVEMENT.

TREE PROTECTION NOTES:

- 1. CONTRACTOR TO PROVIDE PROTECTION AND MAINTENANCE PLAN FOR ALL TREES BEFORE AND DURING CONSTRUCTION. (SEE SPECIFICATIONS)
- 2. REPLACEMENT COSTS FOR DAMAGED OR DEAD TREES WILL BE THE CONTRACTOR'S RESPONSIBILITY AT NO ADDITIONAL COST TO THE OWNER.
- 3. CONTRACTOR TO BRING ANY DISCREPANCIES BETWEEN TREE PROTECTION PLAN AND ACTUAL SITE CONDITIONS TO THE ATTENTION OF OWNER IMMEDIATELY SO THAT WITH

PROPER RESPONSE TIME, THERE WILL BE NO DELAY IN CONSTRUCTION SCHEDULE...

- 4. CONTRACTOR SHALL NOT ALLOW ANY VEHICULAR TRAFFIC, PARKING OF VEHICLES, OR STOCKPILING OF EXCAVATED MATERIAL OR CONSTRUCTION MATERIALS INSIDE OF TREE PROTECTION FENCING OR THE DRIPLINE OF TREES INDICATED TO BE PRESERVED.
- 5. CONSTRUCTION EQUIPMENT MAY NOT OPERATE WITHIN THE DRIP LINE OF A TREE. IF NECESSARY, WRITTEN PERMISSION AND WRITTEN APPROVAL MUST BE ACQUIRED PRIOR TO WORK BEING PERFORMED. WHEN NECESSARY FOR THE PERFORMANCE OF INDICATED WORK, SUCH OPERATIONS SHALL BE CONDUCTED WITH SPECIAL CARE TO AVOID DAMAGING THE TREE AND UNDER DIRECTION OF THE OWNERS REPRESENTATIVE.
- 6. PROTECT TREE ROOT SYSTEMS FROM DAMAGE DONE BY STRIPPING AND REGRADING. IF ANY EXCAVATION AND GRADING WORK SHALL BE DONE IN AREAS NEAR THE PROTECTED TREE ZONES, IT MUST BE DONE BY HAND TOOLS WHILE WORKING NEAR AND WITHIN TREE DRIPLINES.
- 7. PROTECT TREE ROOT SYSTEMS FROM DAMAGE DUE TO NOXIOUS MATERIALS, SPILLAGE, OR DRAINAGE FROM STORED MATERIALS.
- 8. MAINTAIN TREE PROTECTION FENCING IN GOOD CONDITION AT ALL TIMES. TREE PROTECTION FENCING SHALL BE IN PLACE PRIOR TO BEGINNING ANY WORK AND SHALL NOT BE REMOVED UNTIL ALL CONSTRUCTION WORK IS COMPLETE.

- 9. ALL TREE PROTECTION FENCING MUST BE IN PLACE PRIOR TO ANY CLEARING OR SITE WORK. FAILURE TO INSTALL AT APPROPRIATE TIME WILL RESULT DELAY. TREE PROTECTION FENCING SHALL FOLLOW THE SHAPE OF TREE'S DRIPLINE.
- 10.FENCING AND POSTS MUST AT ALL TIMES BE KEPT A MINIMUM OF 15'-0" FROM TREE TRUNKS. FENCING INSTALLED PAST DRIP LINE MUST BE FAR ENOUGH TO PROTECT LIMBS FROM TRUCKS AND MOVING OBJECTS.
- 11.LANDSCAPE ARCHITECT SHALL PROVIDE WRITTEN PERMISSION FOR ANY INCURSIONS INTO TREE PROTECTION AREAS.
- 12.CONTRACTOR RESPONSIBLE FOR MINIMAL PRUNING AND TRIMMING OF THE EXISTING TREES ON SITE, UNDER THE DIRECTION OF THE LANDSCAPE ARCHITECT, ONCE CONSTRUCTION IS COMPLETE.

225.751.4490

NOT FOR CONSTRUCTION

PROJECT NO. ISSUED FOR BID 10/22/2024

MI P

CHECKED DRAWN BY


GENERAL PROJECT NOTES

- 1. CONTRACTOR SHALL COORDINATE AND BE IN COMPLIANCE WITH ALL STATE AND LOCAL 9. THE CONTRACTOR SHALL IMMEDIATELY REPORT TO THE OWNER AND LANDSCAPE ARCHITECT 15. CONTRACTOR SHALL SAW CUT PAVEMENT AT ALL LOCATIONS WHERE REQUIRED PAVEMENT MUNICIPALITIES AS WARRANTED.
- 2. THE CONTRACTOR IS RESPONSIBLE FOR VERIFYING AND/OR OBTAINING ALL REQUIRED PERMITS AND APPROVALS PRIOR TO COMMENCING CONSTRUCTION.
- 3. THE CONTRACTOR IS RESPONSIBLE FOR HORIZONTALLY AND VERTICALLY LOCATING AND PROTECTING ALL PUBLIC AND PRIVATE UTILITIES WHICH LIE IN OR ADJACENT TO THE CONSTRUCTION SITE AT LEAST 48 HOURS PRIOR TO ANY DEMOLITION, GRADING, OR CONSTRUCTION ACTIVITY (CALL LA ONE CALL - 1.800.272.3020).
- COORDINATE WITH ALL UTILITY COMPANIES TO VERIFY THE LOCATION OF ALL UTILITIES. ANY DAMAGE TO UTILITIES SHALL BE THE CONTRACTOR'S RESPONSIBILITY TO CORRECT. 5. CONTRACTOR TO USE CAUTION WHEN WORKING IN VICINITY OF EXISTING OVERHEAD UTILITY 12. THE CONTRACTOR SHALL BE RESPONSIBLE FOR REPAIRING ANY DAMAGE RESULTING FROM
- LINES. CONTRACTOR TO INSTALL APPROPRIATE WARNING SIGNS. 6. ALL DEMOLITION AND CONSTRUCTION TO BE KEPT WITHIN THE BOUNDARIES OF THE SITE OR AS
- DESIGNATED.
- 7. PROTECT STRUCTURES, UTILITIES, VEGETATION, PAVING AND OTHER FACILITIES TO REMAIN FROM DAMAGE CAUSED BY DEMOLITION AND NEW CONSTRUCTION.
- 8. NOTIFY LANDSCAPE ARCHITECT OF ANY CONFLICT AND/OR DISCREPANCIES IN THE 14. CONTRACTOR IS RESPONSIBLE FOR THE REMOVAL OF ALL CONSTRUCTION AND DEMOLITION CONSTRUCTION DOCUMENTS, PRIOR TO THE START OF CONSTRUCTION.

- ANY UNFORESEEN OR ADVERSE CONDITIONS DISCOVERED DURING DEMOLITION AND REMOVAL MEETS AND IS FLUSH WITH PAVEMENT WHICH IS TO REMAIN, UNLESS OTHERWISE CONSTRUCTION OPERATIONS.
- 10. ANY DISCREPANCIES FOUND BETWEEN OR WITHIN THE DRAWINGS AND EXISTING SITE 16. SURPLUS TOPSOIL MAY BE STOCKPILED ON SITE TO BE USED AS FILL MATERIAL, AS NEEDED. CONDITIONS SHALL BE IMMEDIATELY REPORTED TO THE LANDSCAPE ARCHITECT, IN WRITING, COORDINATE LOCATIONS WITH OWNER. WHO SHALL PROMPTLY ADDRESS SUCH INCONSISTENCIES OR AMBIGUITIES. WORK DONE WITHOUT CONSULTING WITH THE LANDSCAPE ARCHITECT AFTER THE DISCOVERY OF SUCH 17. SILT FENCING SHALL REMAIN FOR DURATION OF PROJECT. CONTRACTOR SHALL BE RESPONSIBLE
- DISCREPANCIES, INCONSISTENCIES, OR AMBIGUITIES SHALL BE DONE AT THE CONTRACTOR'S FOR MAINTAINING THE SILT FENCE AT ALL TIMES. 4. EXISTING UNDERGROUND UTILITY LOCATIONS ARE APPROXIMATE. CONTRACTOR SHALL 11. DEVIATION FROM PLANS AND NOTES WITHOUT THE PRIOR CONSENT OF THE OWNER, HIS/HER

REPRESENTATIVE, OR THE LANDSCAPE ARCHITECT MAY BE CAUSE FOR WORK TO BE DEEMED

- UNACCEPTABLE. CONSTRUCTION ACTIVITY TO EXISTING ELEMENTS THAT ARE TO REMAIN AT NO COST TO THE
- 13. IT IS THE RESPONSIBILITY OF THE CONTRACTOR TO REMOVE ALL MUD, DIRT, GRAVEL AND OTHER MATERIALS TRACKED ONTO ANY PRIVATE OR PUBLIC STREETS OR SIDEWALKS. THE CONTRACTOR MUST CLEAN THESE AS NECESSARY. THE CONTRACTOR MUST USE WATER OR OTHER ACCEPTABLE METHODS TO KEEP AIRBORNE DUST TO A REQUIRED MINIMUM.
- DEBRIS IN ACCORDANCE WITH ALL APPLICABLE STATE, FEDERAL AND LOCAL REGULATIONS. NO CONSTRUCTION DEBRIS IS TO BE BURIED OR DEPOSITED ON SITE.

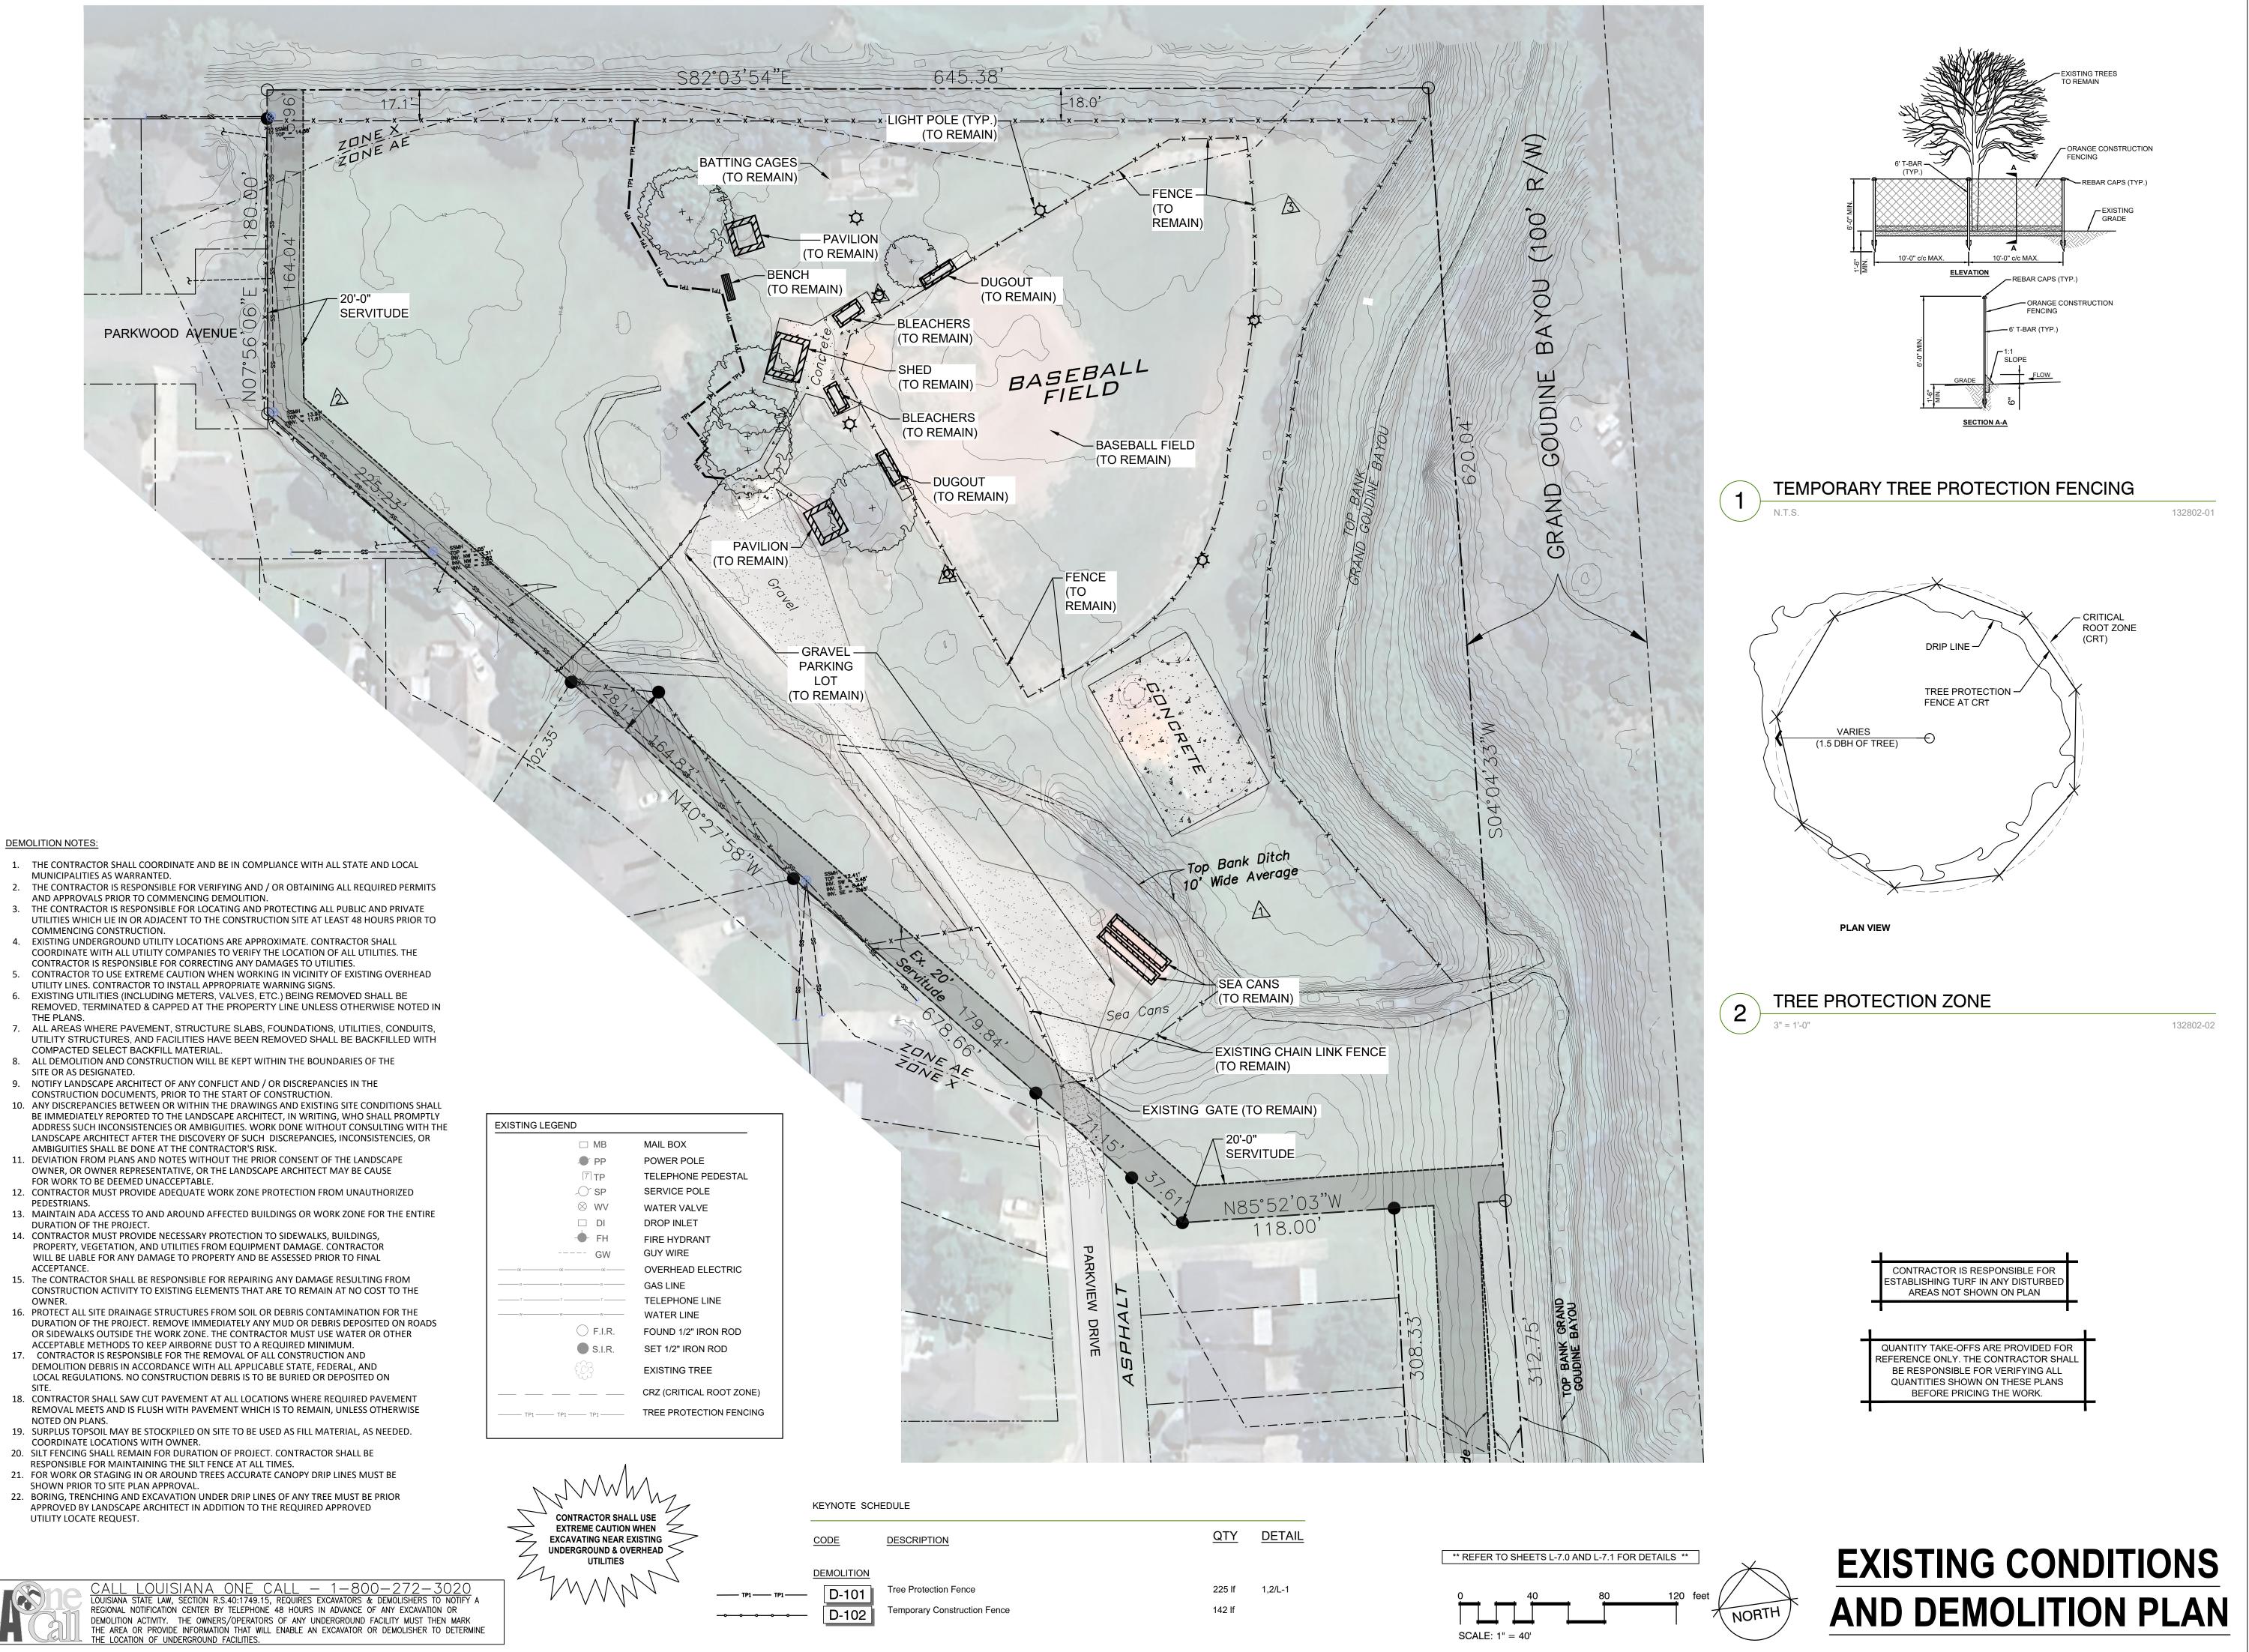

© 2024 DUPLANTIS DESIGN GROUP, P.C.

BATON ROUGE, LA 70810

225.751.4490

BID SET -

NOT FOR

CONSTRUCTION

ISSUED FOR BID

10/22/2024

PROJECT NO.

CHECKED

DRAWN BY

BID SET -**NOT FOR** CONSTRUCTION


PROJECT NO. ISSUED FOR BID 10/22/2024

CHECKED DRAWN BY SHEET



NORTH

SCALE: 1" = 40'

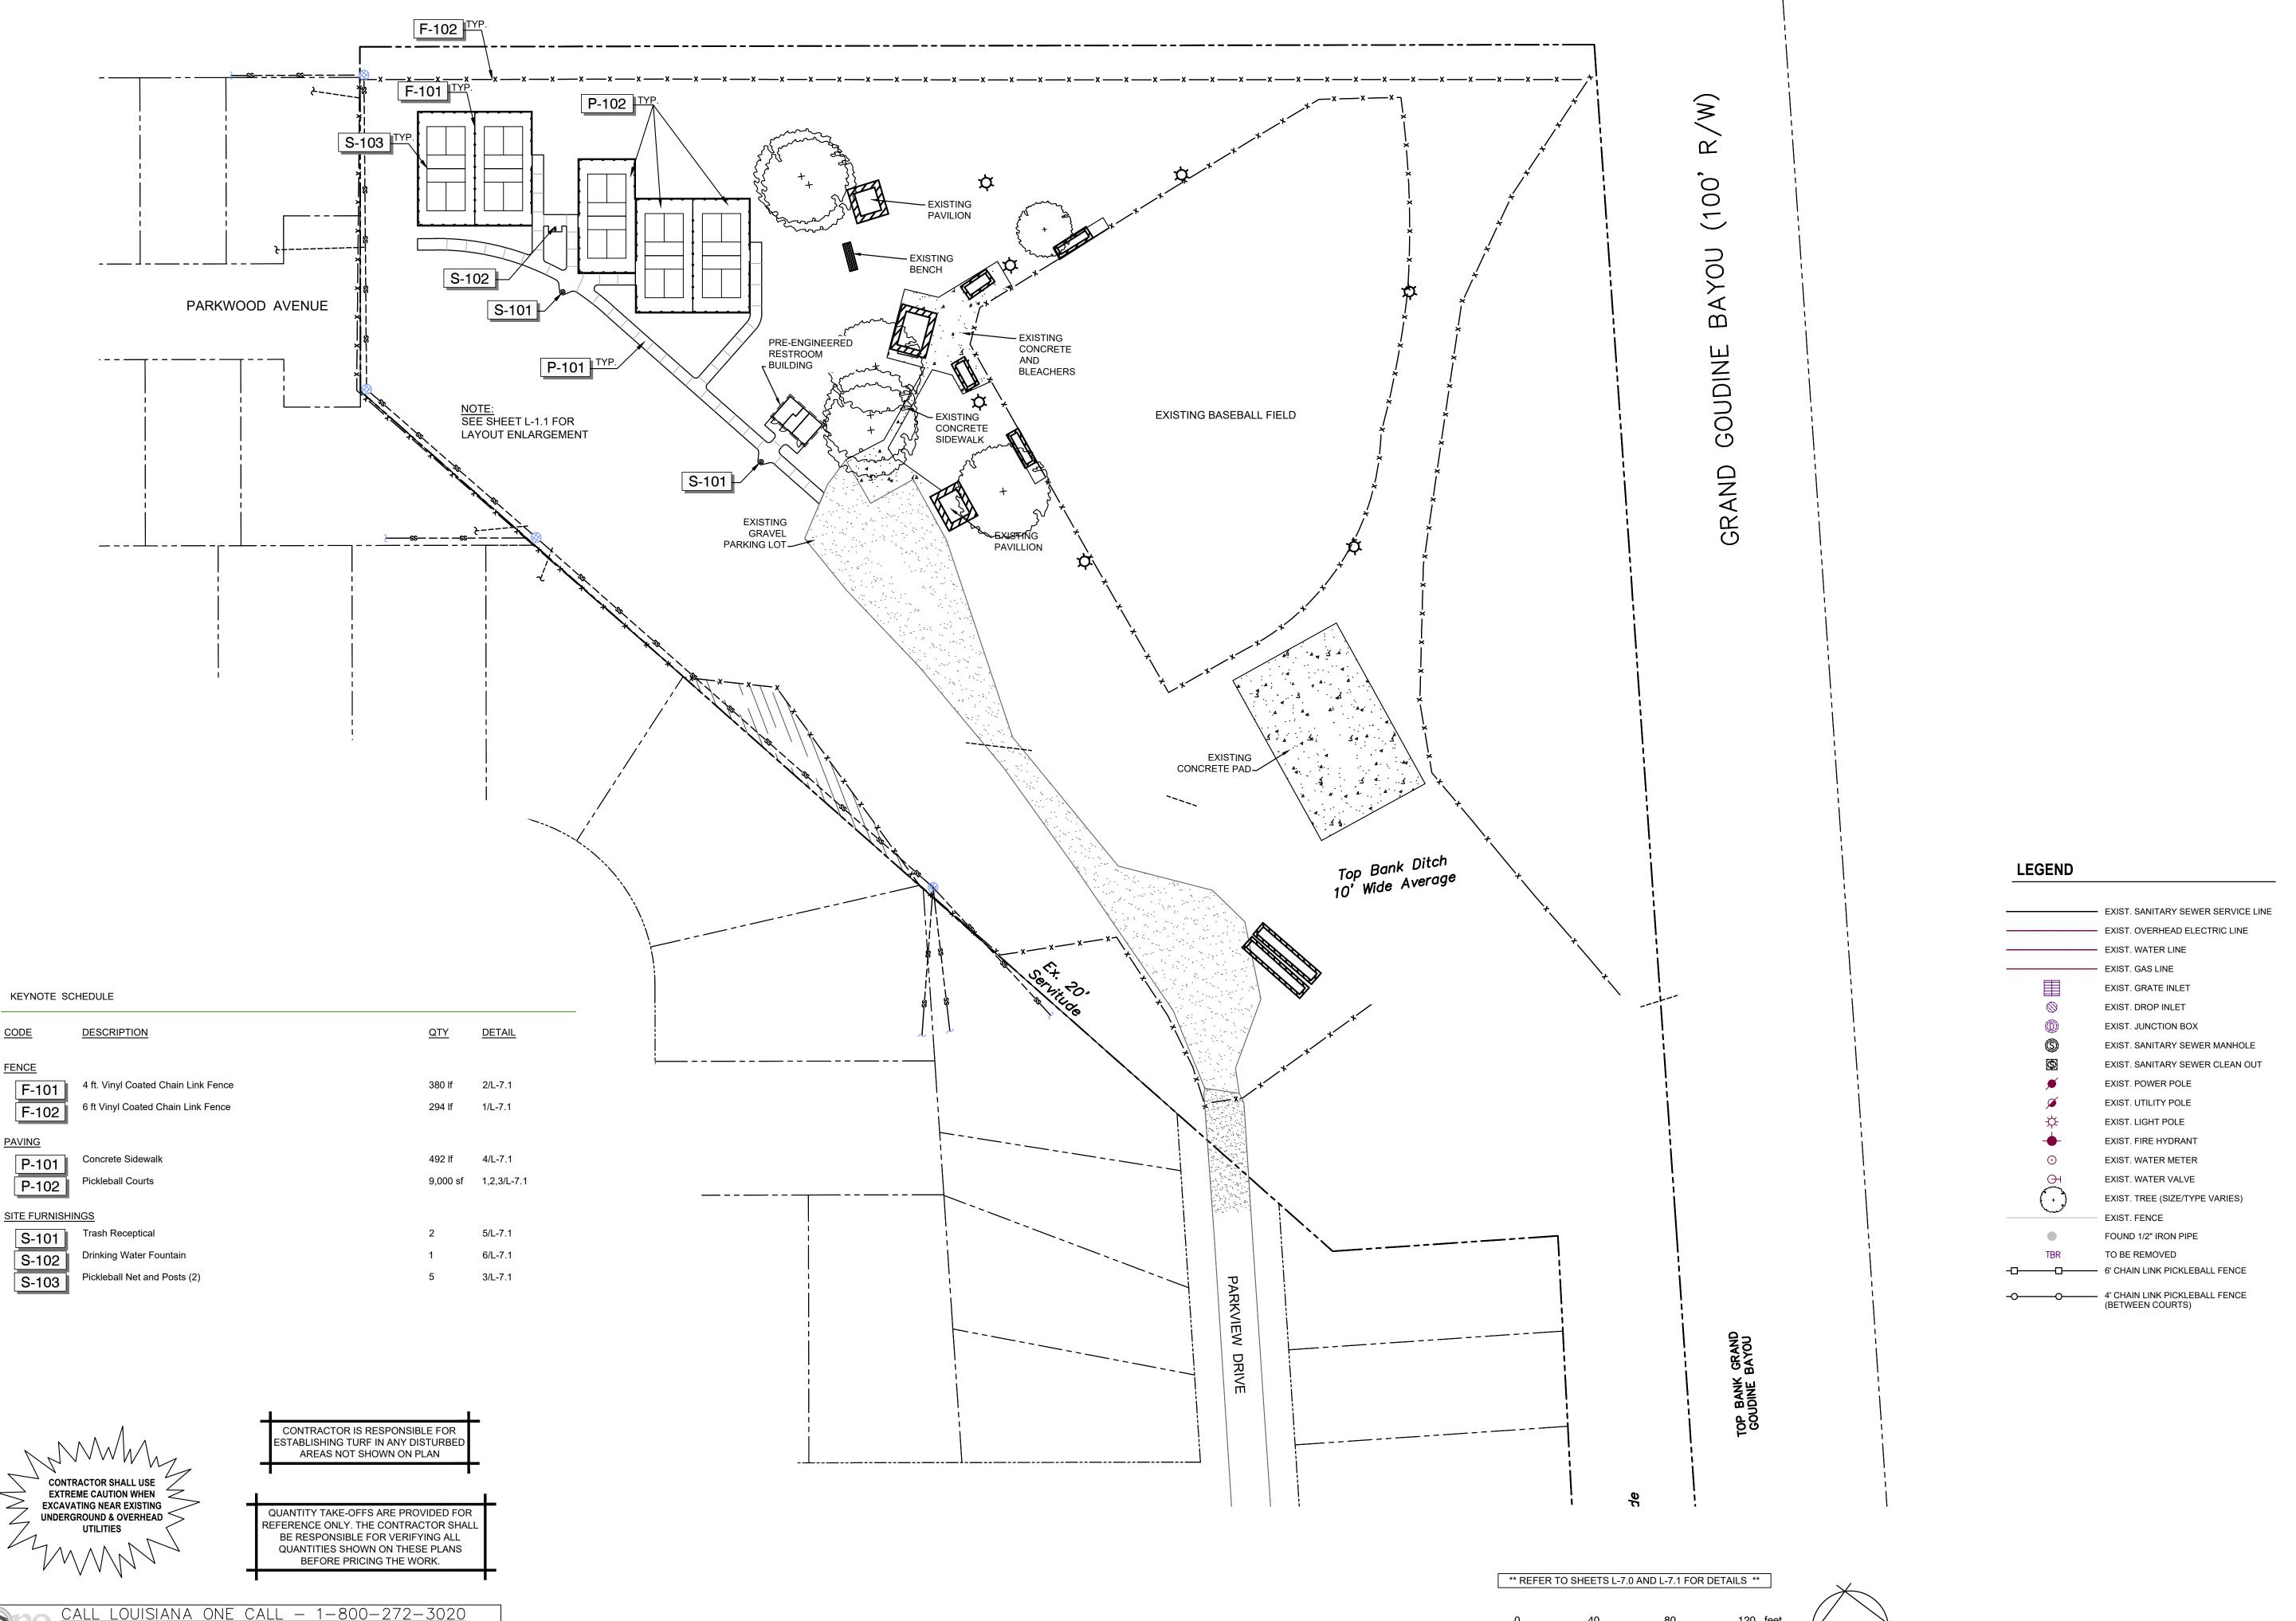

<u>FENCE</u>

F-101

F-102

P-101

P-102


S-101

S-102

REGIONAL NOTIFICATION CENTER BY TELEPHONE 48 HOURS IN ADVANCE OF ANY EXCAVATION OR DEMOLITION ACTIVITY. THE OWNERS/OPERATORS OF ANY UNDERGROUND FACILITY MUST THEN MARK THE AREA OR PROVIDE INFORMATION THAT WILL ENABLE AN EXCAVATOR OR DEMOLISHER TO DETERMINE

BATON ROUGE, LA 70810

CHECKED DRAWN BY

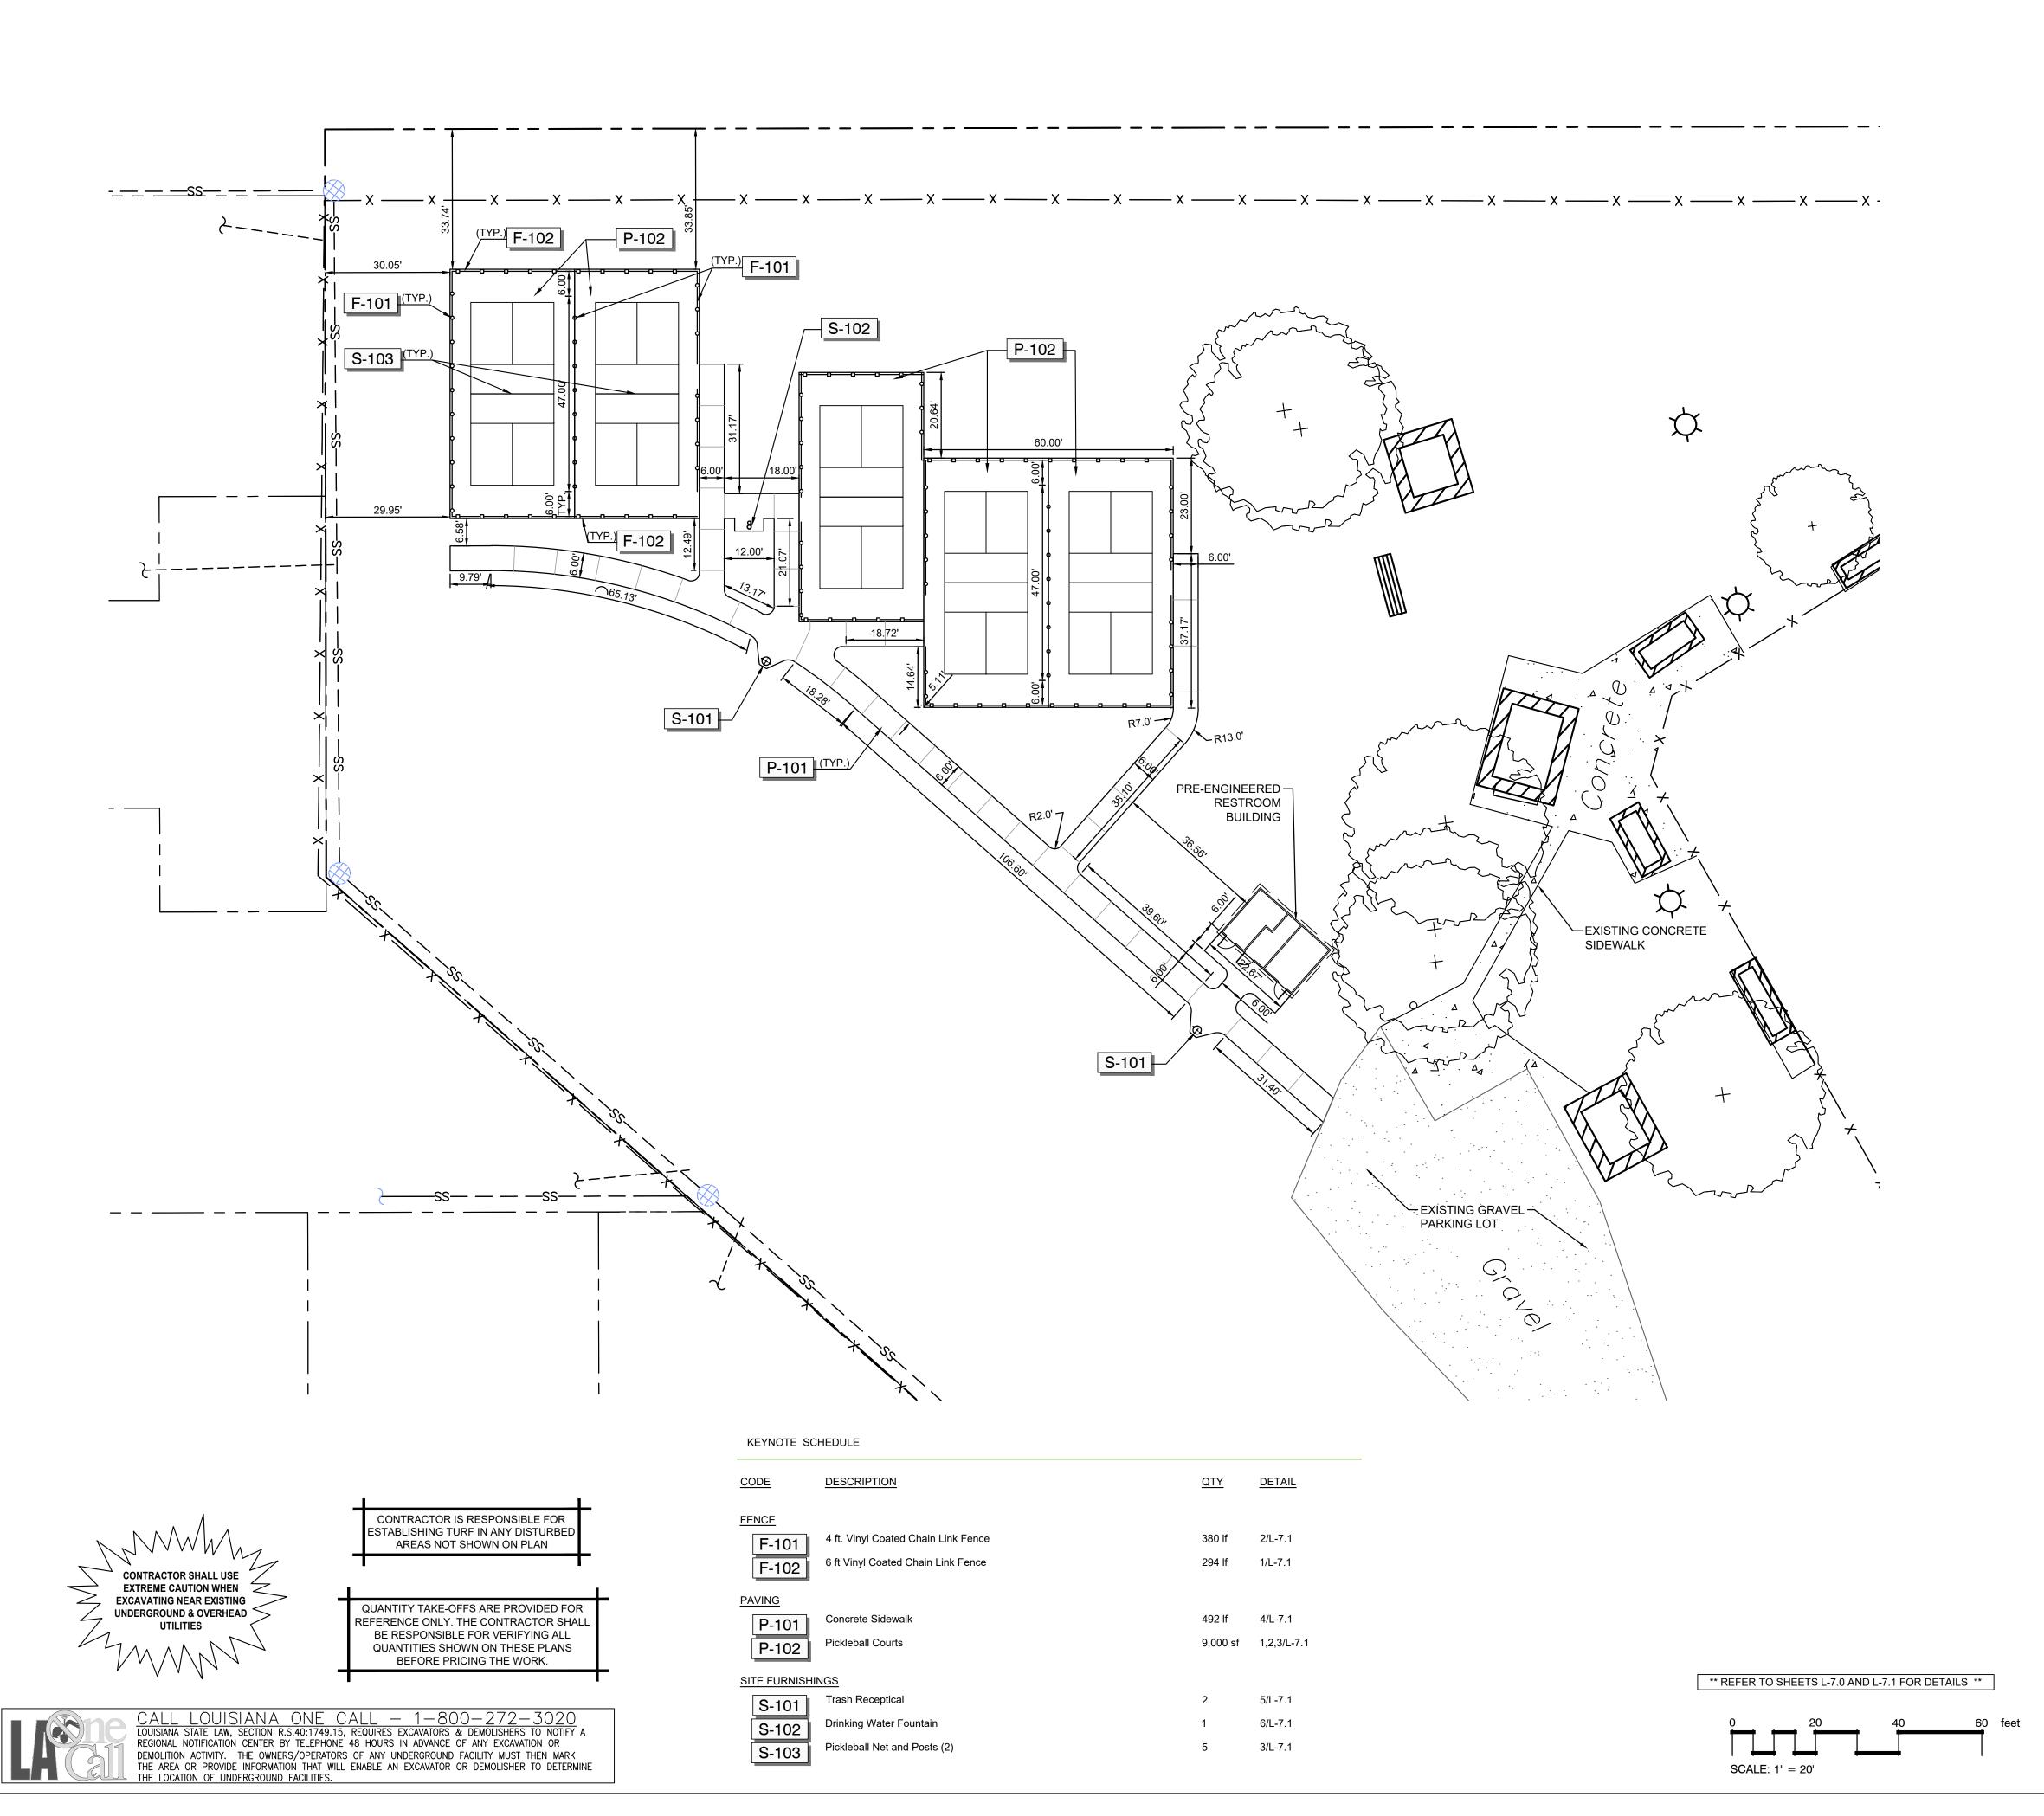

SITE PLAN NOTES:

- 1. ALL UNSURFACED AREAS ARE TO RECEIVE FOUR INCHES OF TOPSOIL, SEED, MULCH, OR SOD, & WATERED UNTIL A HEALTHY STAND OF GRASS IS OBTAINED AS INDICATED ON THE LANDSCAPING PLAN. .
- CONTRACTOR IS RESPONSIBLE FOR PROTECTING EXISTING BENCHMARK. PRIOR TO THE START OF CONSTRUCTION ACTIVITIES THE CONTRACTOR MUST CALL 811 AND THE LOCAL UTILITY PROVIDERS TO HAVE ALL UTILITIES MARKED WITHIN THE PROJECT AREA. AFTER UTILITIES ARE MARKED, THE CONTRACTOR SHALL PERFORM A PLAN IN HAND WALK THRU OF THE ENTIRE PROJECT AREA AND SHALL CONTACT THE CIVIL ENGINEER IMMEDIATELY IF THERE ARE ANY DEVIATIONS IN THE LOCATIONS OF EXISTING UTILITIES
- 4. ALL NECESSARY PERMITS & APPROVALS FROM AGENCIES GOVERNING THE CONSTRUCTION OF THIS WORK SHALL BE SECURED

SHOWN IN THE PLANS AND/OR THE PRESENCE OF UTILITIES THAT ARE NOT SHOWN IN THE

- PRIOR TO BEGINNING CONSTRUCTION. 5. THE CONTRACTOR IS RESPONSIBLE FOR THE PROTECTION OF ALL AREAS INDICATED TO REMAIN UNDISTURBED OR TO REMAIN AS BUFFERS AND ALL PROPERTY MARKERS. CONTRACTOR SHALL REPLACE ALL PINS ELIMINATED OR DAMAGED DURING CONSTRUCTION.
- 6. CONTRACTOR IS RESPONSIBLE FOR REPAIRS OR DAMAGE TO ANY EXISTING IMPROVEMENTS DURING CONSTRUCTION, SUCH AS, BUT NOT LIMITED TO, DRAINAGE, UTILITIES, PAVEMENT, STRIPING, CURB, ETC., REPAIRS SHALL BE EQUAL TO OR BETTER THAN EXISTING CONDITIONS. CONTRACTOR SHALL MATCH EXISTING PAVEMENT IN GRADE & ALIGNMENT.
- 8. ALL WORK SHOWN SHALL BE DONE IN ACCORDANCE WITH CONSTRUCTION DOCUMENTS.


LEGEND

----- OE ---- EXIST. OVERHEAD ELECTRIC LINE --w---w--- EXIST. WATER LINE --g----g--- EXIST. GAS LINE EXIST. GRATE INLET EXIST. DROP INLET EXIST. JUNCTION BOX EXIST. SANITARY SEWER MANHOLE EXIST. SANITARY SEWER CLEAN OUT EXIST. POWER POLE EXIST. UTILITY POLE EXIST. LIGHT POLE EXIST. FIRE HYDRANT EXIST. WATER METER EXIST. WATER VALVE EXIST. TREE (SIZE/TYPE VARIES) EXIST. FENCE FOUND 1/2" IRON PIPE TO BE REMOVED 6' CHAIN LINK PICKLEBALL FENCE

4' CHAIN LINK PICKLEBALL FENCE (BETWEEN COURTS)

CHECKED DRAWN BY

GRADING PLAN © 2024 DUPLANTIS DESIGN GROUP, P.C.

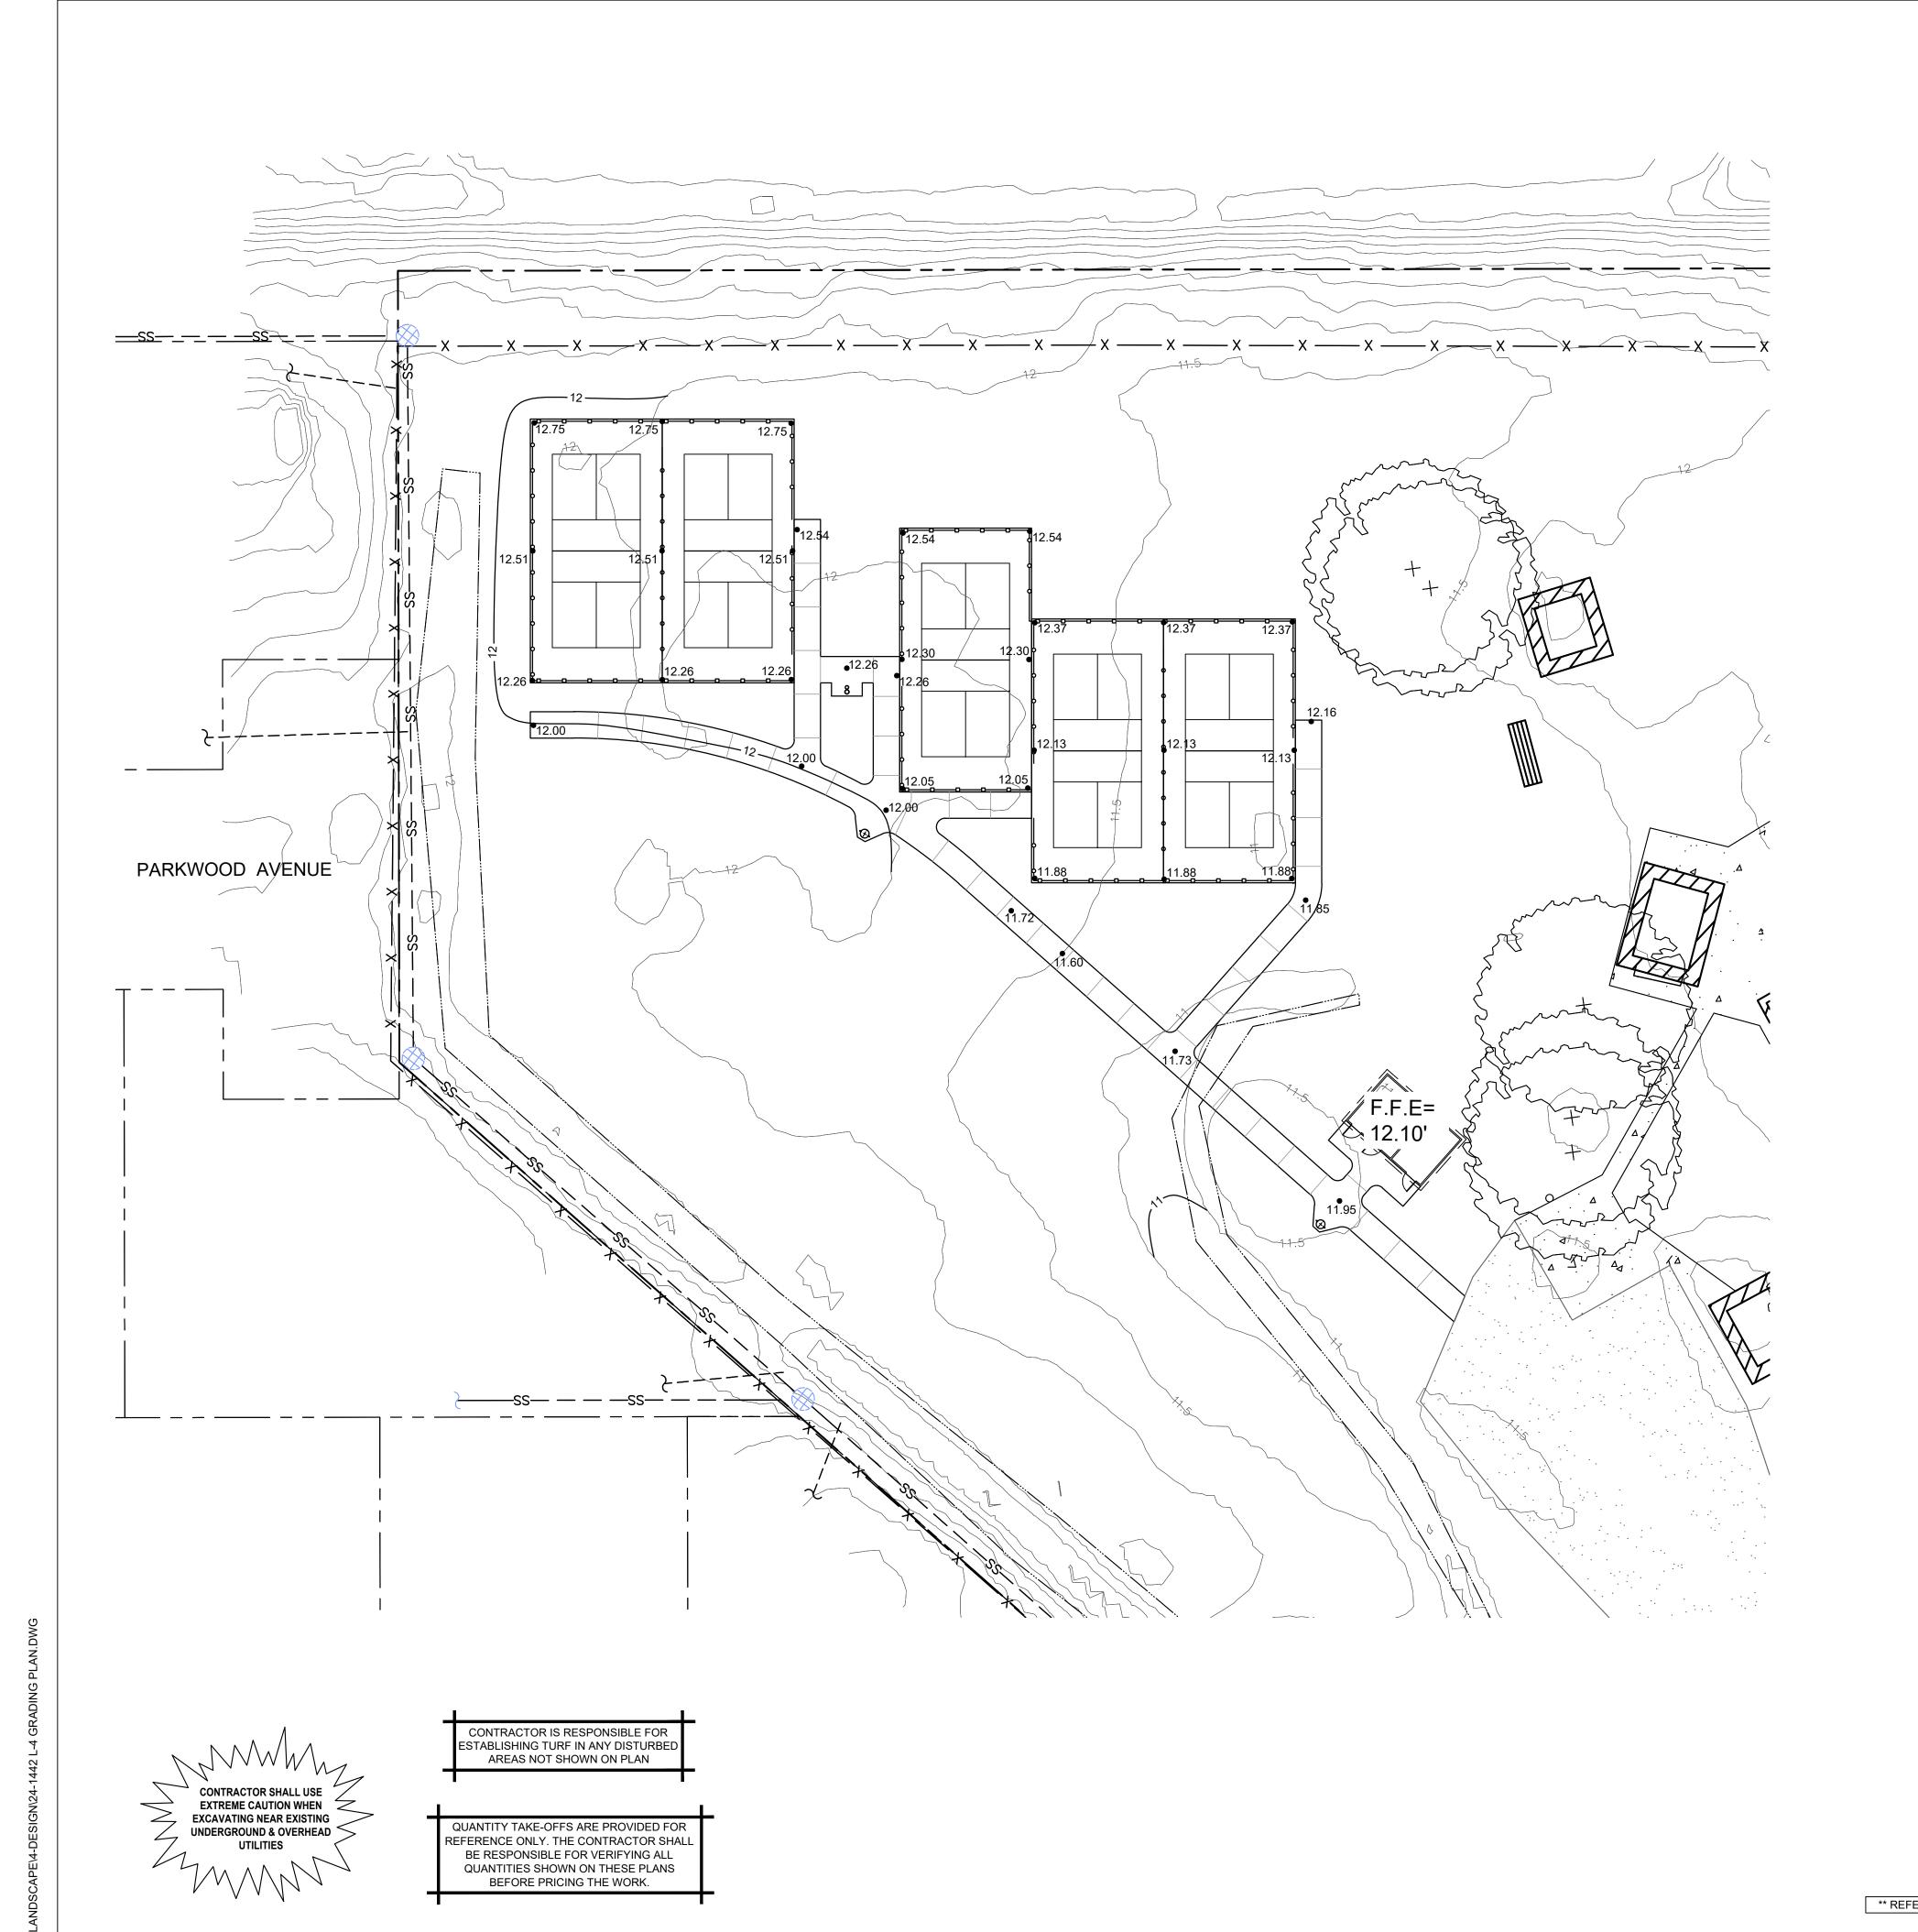

REGIONAL NOTIFICATION CENTER BY TELEPHONE 48 HOURS IN ADVANCE OF ANY EXCAVATION OR DEMOLITION ACTIVITY. THE OWNERS/OPERATORS OF ANY UNDERGROUND FACILITY MUST THEN MARK THE AREA OR PROVIDE INFORMATION THAT WILL ENABLE AN EXCAVATOR OR DEMOLISHER TO DETERMINE

NOTES TO CONTRACTOR:

- 1. CONTRACTOR SHALL BEAR THE FULL RESPONSIBILITY IN VERIFYING LOCATIONS OF EXISTING SITE UTILITIES
- AND SHALL BE RESPONSIBLE FOR ANY DAMAGE TO SAID UTILITIES DURING CONSTRUCTION. 2. PROVIDE PROTECTION TO ALL EXISTING AND FINISHED WORK UNTIL ACCEPTED BY THE OWNER. 3. CONTRACTOR TO LAYOUT ALL WORK. LAYOUT TO BE APPROVED BY OWNER & LANDSCAPE ARCHITECT
- PRIOR TO INSTALLATION. 4. DETAILS SHOW ONLY VISUAL INTENT. CONTRACTOR RESPONSIBLE FOR STRUCTURAL INTEGRITY OF ALL
- 5. QUANTITIES ARE GIVEN FOR INFORMATIONAL PURPOSES ONLY. THE CONTRACTOR SHALL BE RESPONSIBLE FOR PERFORMING AN INDEPENDENT TAKE-OFF TO DETERMINE QUANTITIES THAT MEET THE DESIGN INTENT.
- 6. CALL THE LANDSCAPE ARCHITECT AT (225) 751-4490 TO ANSWER ANY QUESTIONS. 7. ALL PLANTING ISLANDS SHALL BE BACK-FILLED WITH FERTILE TOPSOIL. PROVIDE SAMPLE OF TOPSOIL, BED
- MATERIAL, & MULCH TO LANDSCAPE ARCHITECT. 8. FINISH GRADE OF SOD PANELS MUST BE FLUSH WITH TOP OF CURB OR EDGE OF PAVEMENT IN A
- STRAIGHT, UNIFORM PATTERN FREE FROM ALL DEBRIS. 9. EXISTING TREES, SHRUBS, AND SOD NOT DESIGNATED FOR REMOVAL SHALL BE REPLACED BY
- CONTRACTOR IF DAMAGED DURING CONSTRUCTION. 10. TOTALLY GRUB AREAS TO RECEIVE BEDS AND/OR SOD BY CHEMICALLY ERADICATE EMERGING
- VEGETATION; SCARIFYING EXISTING VEGETATION AFTER VEGETATION IS DEAD, THEN PROCEEDING WITH PROPER BED OR SOD INSTALLATION IN ACCORDANCE WITH THE TREE SPECS.
- 11. APPLY AN APPROVED PRE-EMERGENT HERBICIDE TO ALL BED PREP AREAS. 12. CONTRACTOR TO COORDINATE ALL SCHEDULING OF WORK WITH LANDSCAPE ARCHITECT IN ORDER THAT
- SITE DISRUPTION IS KEPT TO A MINIMUM AND SAFETY PRECAUTIONS MAINTAINED. 13. ANY VARIANCE FROM SPECIFIED PLANT MATERIAL'S SIZE (CONTAINER, CALIPER, HEIGHT, & SPREAD) AND SPECIES WILL BE REJECTED WITHOUT THE PRIOR WRITTEN AUTHORIZATION FROM THE LANDSCAPE ARCHITECT.
- 14. THE CONTRACTOR SHALL SUBMIT PHOTOGRAPHS OF PLANT MATERIAL TO THE LANDSCAPE ARCHITECT PRIOR TO SELECTION AND DELIVERY. THE LANDSCAPE ARCHITECT RESERVES THE RIGHT TO PRE-TAG TREES AT NURSERY SITE PRIOR TO DELIVERY, BUT WILL NOT RELINQUISH THE RIGHT TO REJECT ANY PLANT MATERIAL THAT IS DAMAGED OR DOES NOT MEET SPECIFICATIONS.
- 15. ALL GRADES MUST BE APPROVED BY THE LANDSCAPE ARCHITECT PRIOR TO INSTALLATION OF SOD, SHRUBS, & TREES. CALL LANDSCAPE ARCHITECT 72 HOURS PRIOR TO INSTALLATION.
- 16. ALL UNDERGROUND UTILITIES SHALL BE LOCATED PRIOR TO THE START OF CONSTRUCTION.
- 17. REFER TO WRITTEN SPECIFICATIONS FOR DETAILED REQUIREMENTS 18. CONTRACTOR TO INSURE POSITIVE DRAINAGE AWAY FROM BUILDING FOR ALL WORK.
- 19. ALL AREAS SHALL RECEIVE A FINISH GRADE THAT ALLOWS FOR POSITIVE DRAINAGE.
- 20. CONTRACTOR SHALL MEET OR EXCEED ALL LOCAL JURISDICTIONAL REQUIREMENTS REQUARDLESS OF WHAT IS DEPICTED ON SAID PLANS AND SPECIFICATIONS.

LEGEND - EXISTING CONDITIONS

□ MB	MAIL BOX
₽P PP	POWER POLE
TTP	TELEPHONE PEDESTAL
	SERVICE POLE
⊗ wv	WATER VALVE
□ DI	DROP INLET
- ⊕ FH	FIRE HYDRANT
GW	GUY WIRE
OE	OVERHEAD ELECTRIC
———— G ————	GAS LINE
——т	TELEPHONE LINE
	WATER LINE
○ F.I.R.	FOUND 1/2" IRON ROD
S.I.R.	SET 1/2" IRON ROD
	EXISTING TREE
85.00	EXISTING SPOT ELEVATIO
7.53	PROPOSED SPOT ELEVAT
\ 2%	SLOPE
2	PIPE NUMBER
(A2)	STRUCTURE NUMBER

LEGEND - TOPO

EXISTING CONTOUR

EXISTING SPOT ELEVATION PROPOSED SPOT ELEVATION

ABBREVIATIONS

BOTTOM OF WALL TOP OF STEP TOP OF GRATE
TOP OF STRETCHER CURB TOP OF WALL INVERT ELEVATION




BATON ROUGE, LA 70810 225.751.4490 BID SET -**NOT FOR**

CONSTRUCTION PROJECT NO. ISSUED FOR BID 10/22/2024

CHECKED DRAWN BY

UTILITY PLAN © 2024 DUPLANTIS DESIGN GROUP, P.C.

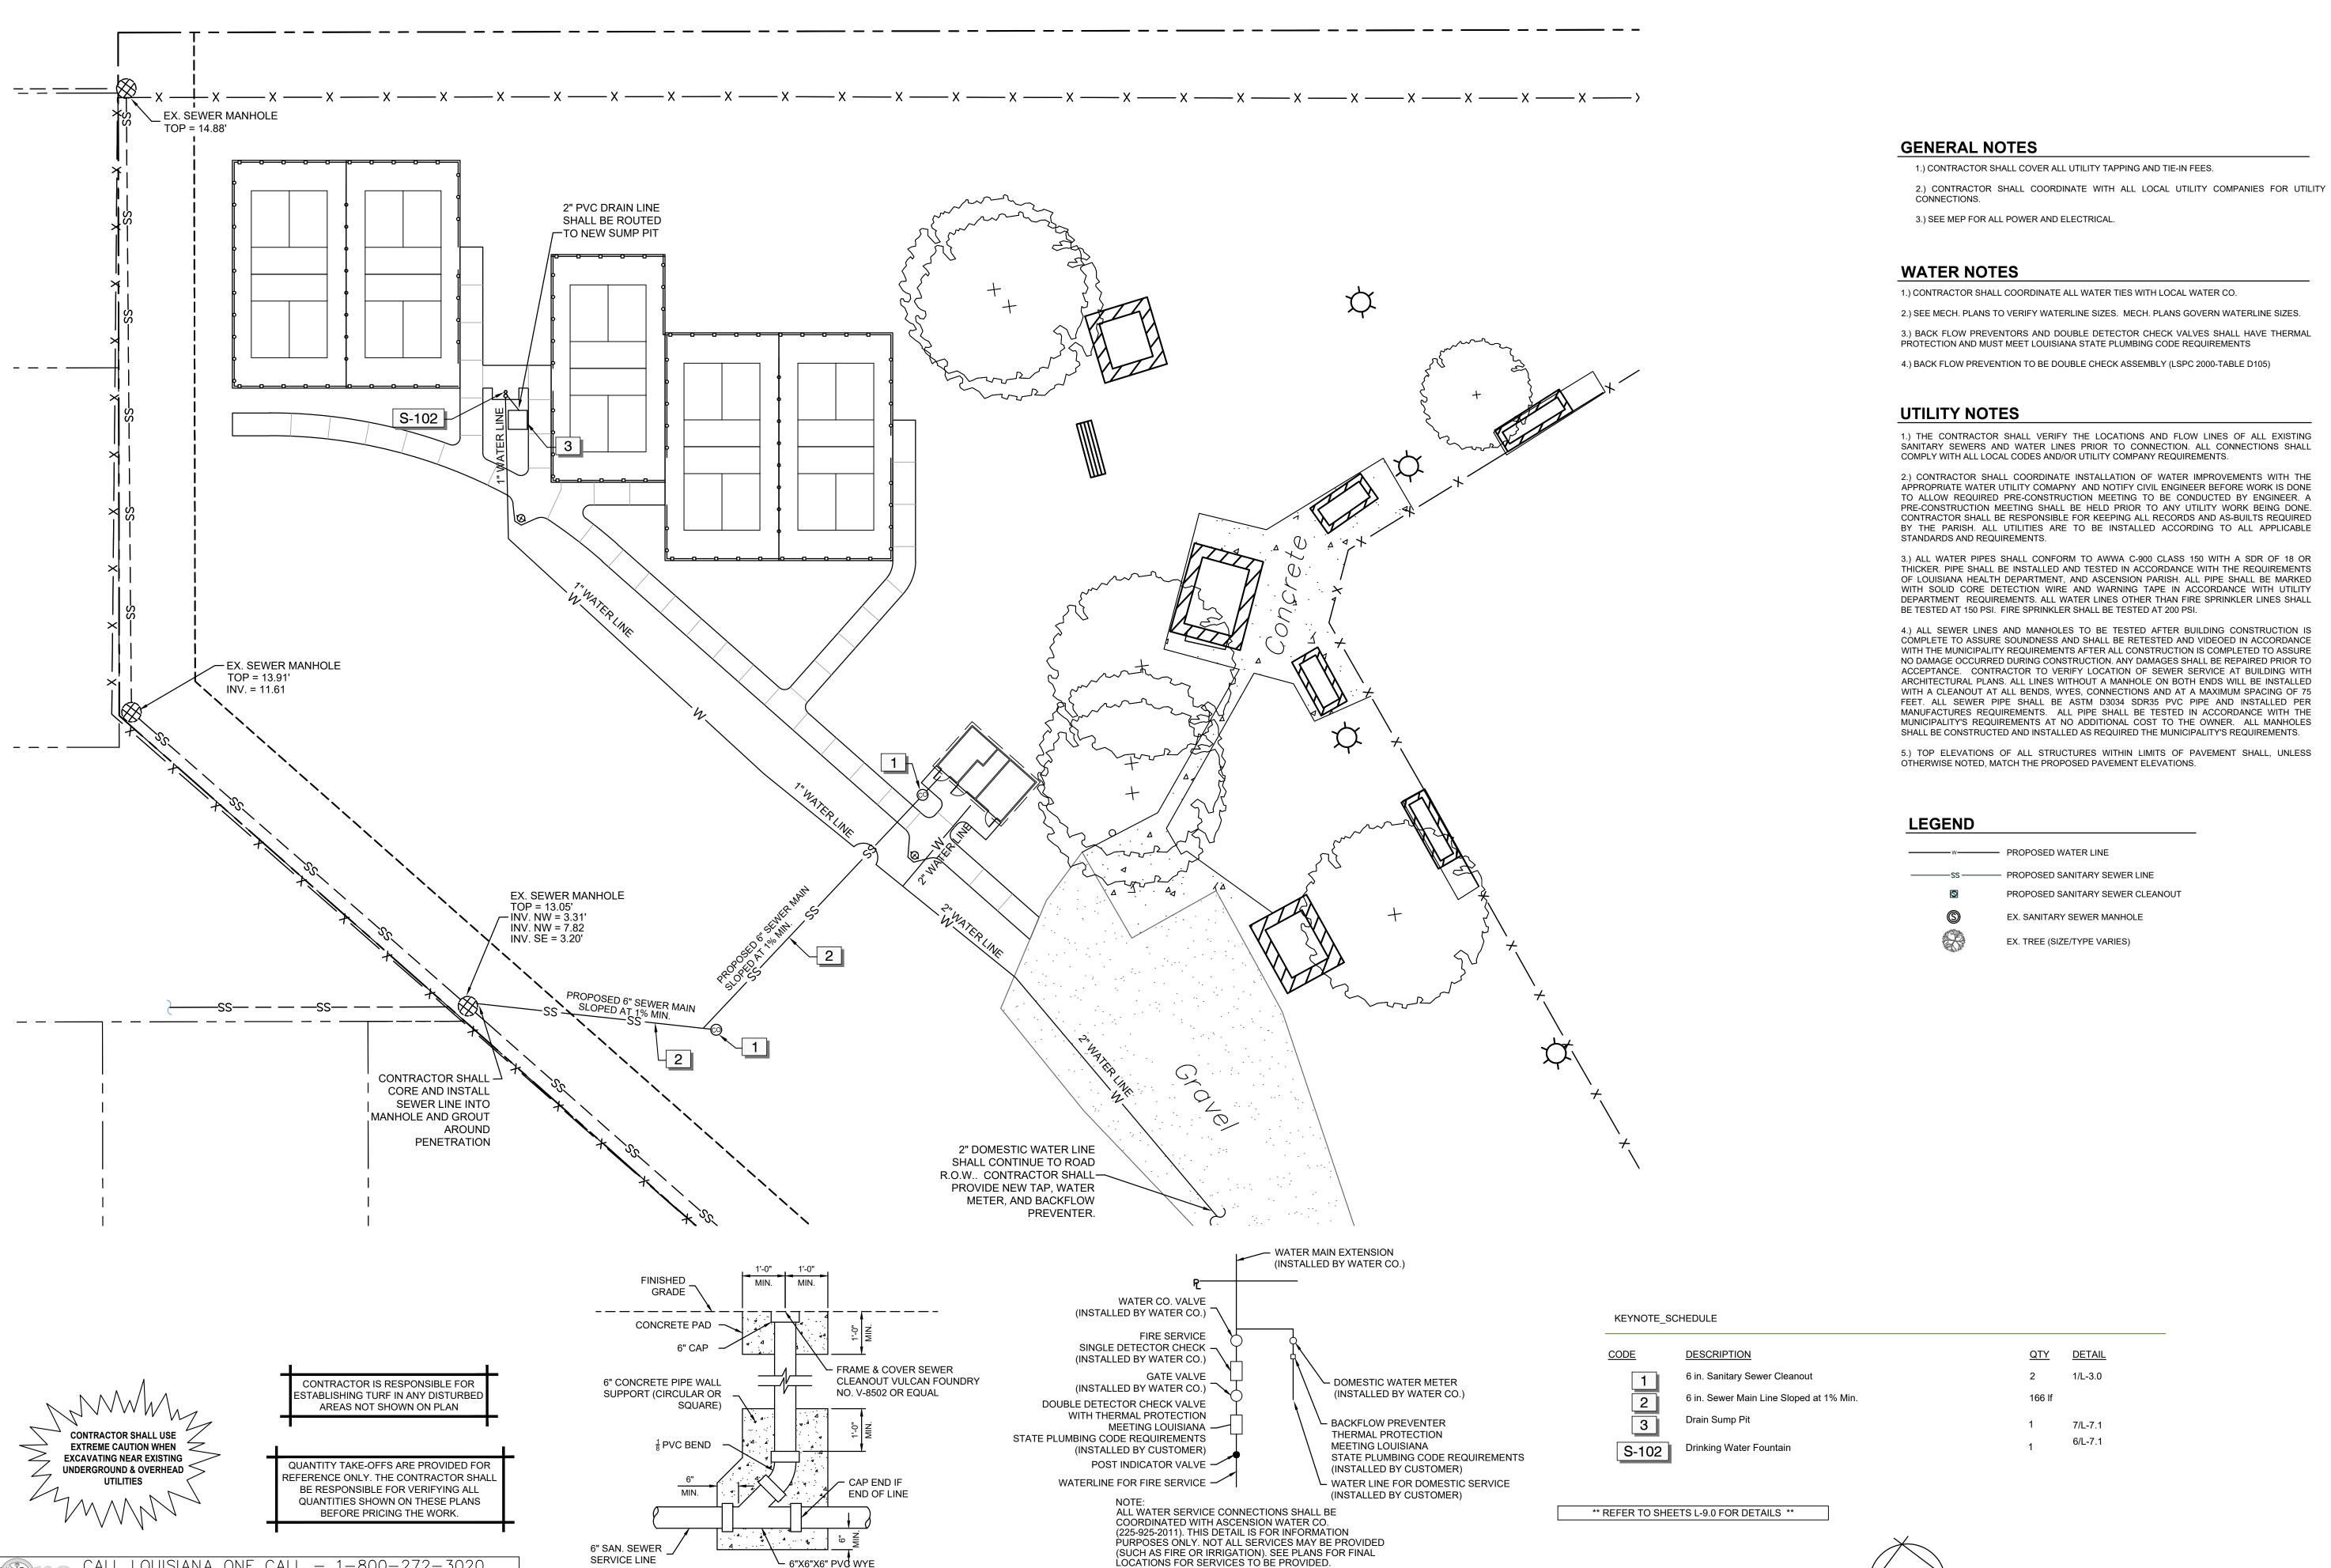

WATER CONNECTION DETAIL

SCALE: 1" = 20'

SERVICE LINE

6" SANITARY SEWER CLEANOUT

CALL LOUISIANA ONE CALL - 1-800-272-3020 LOUISIANA STATE LAW, SECTION R.S.40:1749.15, REQUIRES EXCAVATORS & DEMOLISHERS TO NOTIFY A

REGIONAL NOTIFICATION CENTER BY TELEPHONE 48 HOURS IN ADVANCE OF ANY EXCAVATION OR DEMOLITION ACTIVITY. THE OWNERS/OPERATORS OF ANY UNDERGROUND FACILITY MUST THEN MARK THE AREA OR PROVIDE INFORMATION THAT WILL ENABLE AN EXCAVATOR OR DEMOLISHER TO DETERMINE

THE LOCATION OF UNDERGROUND FACILITIES.

REGIONAL NOTIFICATION CENTER BY TELEPHONE 48 HOURS IN ADVANCE OF ANY EXCAVATION OR DEMOLITION ACTIVITY. THE OWNERS/OPERATORS OF ANY UNDERGROUND FACILITY MUST THEN MARK THE AREA OR PROVIDE INFORMATION THAT WILL ENABLE AN EXCAVATOR OR DEMOLISHER TO DETERMINE

225.751.4490

BID SET -**NOT FOR** CONSTRUCTION

PROJECT NO. ISSUED FOR BID

10/22/2024

CHECKED DRAWN BY

BID SET -**NOT FOR** CONSTRUCTION

PROJECT NO. ISSUED FOR BID 10/22/2024

CHECKED DRAWN BY


PLANT SCHEDULE

COMMON NAME BOTANICAL NAME MAT

GROUND COVERS ERE OPH 16,303 sf Centipede Sod Eremochloa ophiuroides Sod

LANDSCAPE PLANTING NOTES:


- 1.) Contractor shall bear full responsibility in verifying locations of existing site utilities and shall be responsible for any damage to said utilities during construction.
- 2.) The contractor shall be responsible in determining quantities that meet the design intent.
- 3.) Existing trees, shrubs, and sod not designed for removal shall be replaced if damaged during
- 4.) Remove waste materials, including grass, vegetation, and turf, and legally dispose of it off of Owner's property.
- 5.) Totally grub areas to receive sod by chemically eradicating emerging vegetation, removing existing vegetation after vegetation is dead, then proceeding with proper sod installation in accordance with the Planting Plan. Remove roots, plants, sods, stones, clay lumps, and other extraneous materials harmful to plant growth.
- 6.) Lay sod to form a solid mass with tightly fitted joints. Butt ends and sides of sod; DO NOT OVERLAP OR STRETCH. Stagger sod strips or pads to offset joints in adjacent courses. Avoid damage to subgrade or sod during installation. Tamp and roll lightly to ensure contact with subgrade, eliminate air pockets, and form a smooth surface.
- 7.) Grade lawn and grass areas to a smooth, even surface with loose, uniformly fine texture. Roll and rake, remove ridges, and fill in depressions to meet finish grades and ensure positive drainage.
- 8.) Contractor shall ensure positive drainage away from buildings for all work.
- 9.) Provide protection to all finished work until accepted by owner.
- 10.) Warranty Period: Sod: 6 months
- 11.) Contractor is to insure that all disturbed areas on site are to be sodded. This may be areas in addition to what is indicated on the plan.

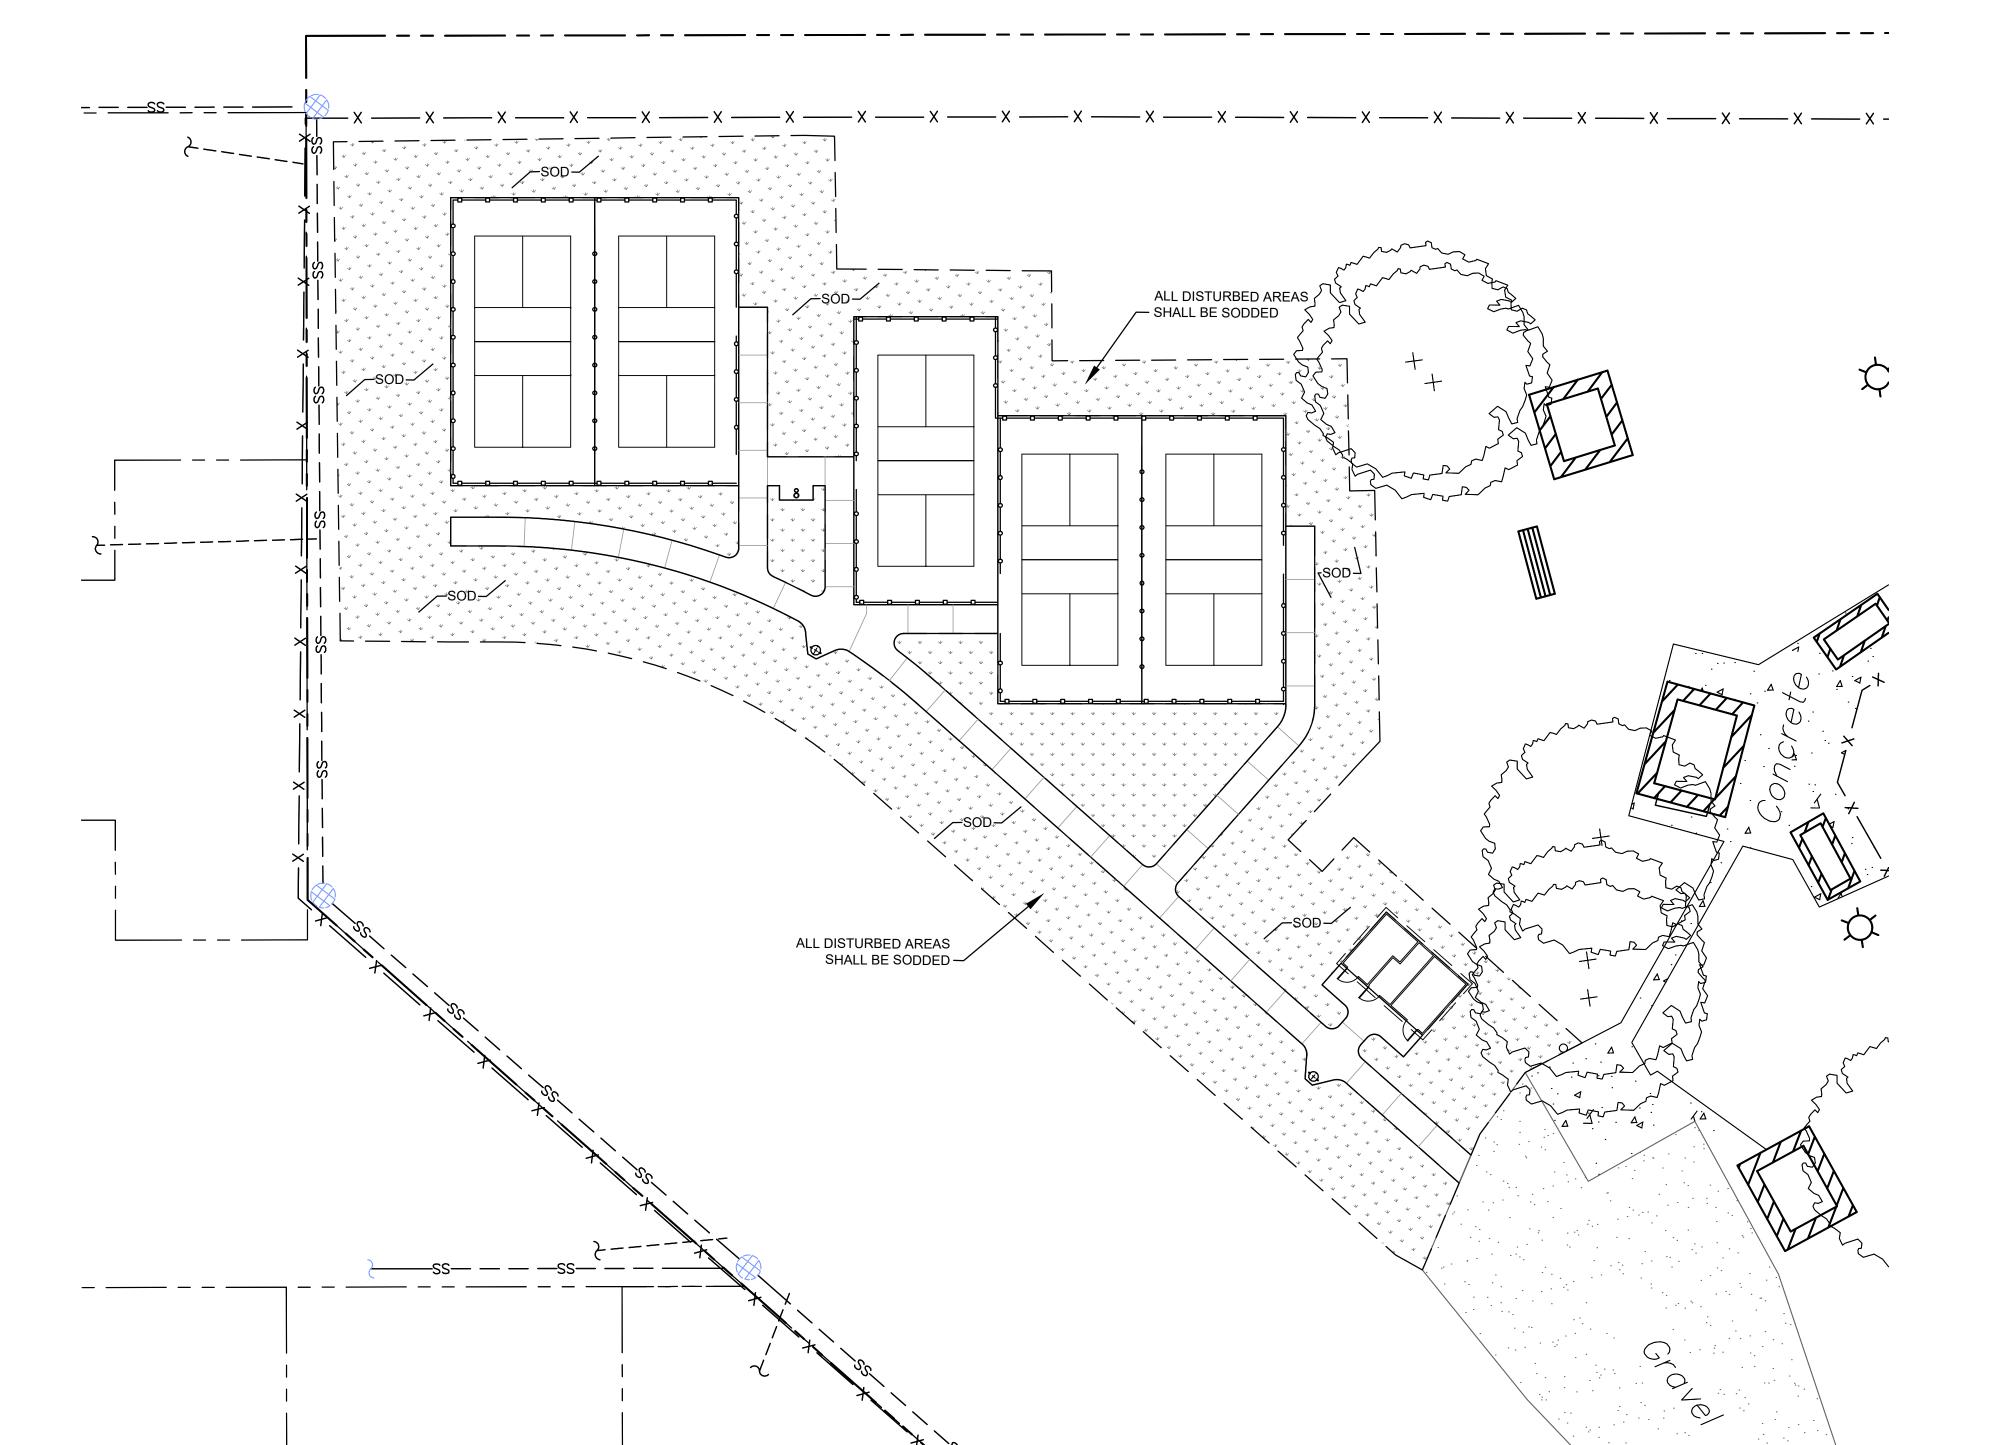

CONTRACTOR SHALL USE
EXTREME CAUTION WHEN
EXCAVATING NEAR EXISTING CONTRACTOR IS RESPONSIBLE FOR UNDERGROUND & OVERHEAD ESTABLISHING TURF IN ANY DISTURBED AREAS NOT SHOWN ON PLAN QUANTITY TAKE-OFFS ARE PROVIDED FOR REFERENCE ONLY. THE CONTRACTOR SHALL BE RESPONSIBLE FOR VERIFYING ALL REGIONAL NOTIFICATION CENTER BY TELEPHONE 48 HOURS IN ADVANCE OF ANY EXCAVATION OR QUANTITIES SHOWN ON THESE PLANS BEFORE PRICING THE WORK. DEMOLITION ACTIVITY. THE OWNERS/OPERATORS OF ANY UNDERGROUND FACILITY MUST THEN MARK

THE AREA OR PROVIDE INFORMATION THAT WILL ENABLE AN EXCAVATOR OR DEMOLISHER TO DETERMINE


EXISTING LEGEND MAIL BOX POWER POLE TELEPHONE PEDESTAL SERVICE POLE WATER VALVE DROP INLET FIRE HYDRANT **GUY WIRE** OVERHEAD ELECTRIC GAS LINE TELEPHONE LINE WATER LINE FOUND 1/2" IRON ROD S.I.R. SET 1/2" IRON ROD EXISTING TREE

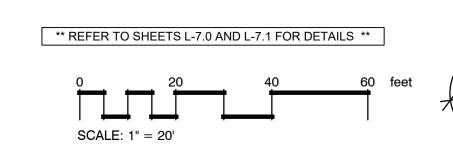

LANDSCAPE **PLANTING PLAN**

CHECKED DRAWN BY

FOR INFORMATIONAL AND GRAPHIC PURPOSES ONLY *CONTRACTOR SHALL PROVIDE SEALED SHOP DRAWINGS* *AND SECURE ALL PERMITS AND APPROVALS FOR STRUCTURE*

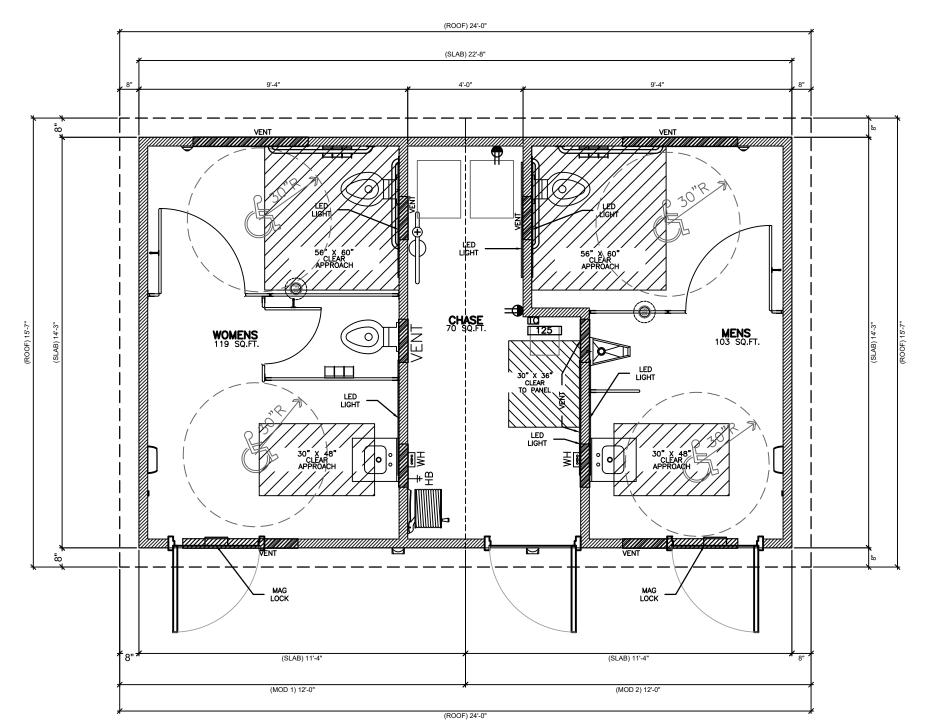



PRE-ENGINEERED RESTROOM - FLOOR PLAN

PRODUCT: CORWORTH RESTROOM FACILITIES

PRODUCT NUMBER: B312

BUILDING BASIS OF DESIGN


CONTACT: **BRIAN CRAFT**


1-512-222-5454 WWW.CORWORTH.COM

- 1. INSTALL PER MANUFACTURER'S SPECIFICATIONS.
- 2. CONTRACTOR SHALL PROVIDE STAMPED SHOP DRAWINGS FOR REVIEW AND APPROVAL BY LANDSCAPE ARCHITECT.
- 3. CONTRACTOR MAY SUBMIT ALTERNATIVE VENDORS TO BE CONSIDERED AS ACCEPTED SUBSTITUTE.
- 4. CONTRACTOR RESPONSIBLE FOR SECURING STATE FIRE MARSHALL APPROVALS AND PARISH BUILDING PERMITS FOR STRUCTURE.
- 5. CONTRACTOR SHALL COORDINATE AND SECURE ALL UTILITY CONNECTIONS

NOTES

- 1.BUILDING TO BE CONSTRUCTED OFFSITE AND CRANED INTO PLACE.
- 2.MINIMUM 10" OF NATIVE SOIL & ORGANICS TO BE REMOVED FROM
- 3.CONTRACTOR TO CONSTRUCT BUILDING PAD TO 95% COMPACTION.
- 4.CONTRACTOR SHALL BRING WATER AND ELECTRIC CONNECTIONS WITHIN 5' OF RESTROOM BUILDING PAD PRIOR TO RESTROOM DELIVERY.
- 5.ON DELIVERY OF RESTROOM, CONTRACTOR TO MAKE FINAL UTILITY CONNECTIONS TO FACILITY PRIOR TO RESTROOM BUILDING VENDOR
- 6.RESTROOM BUILDING TO HAVE AN 8" REINFORCED CONCRETE SLAB ATTACHED TO BUILDING ON ARRIVAL

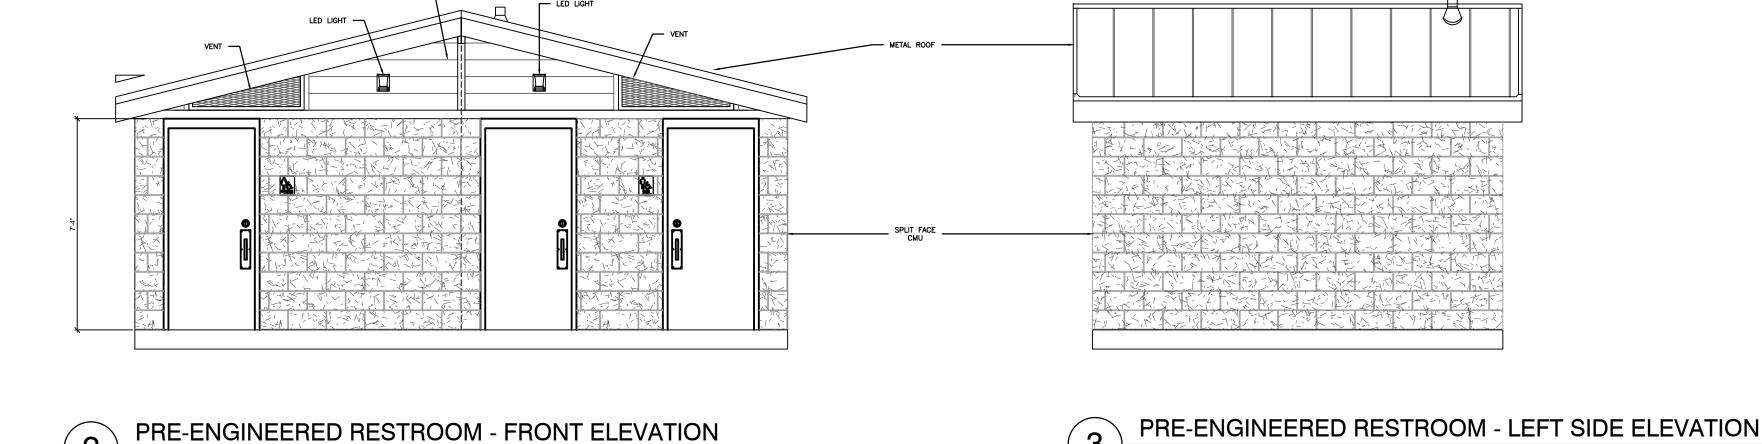

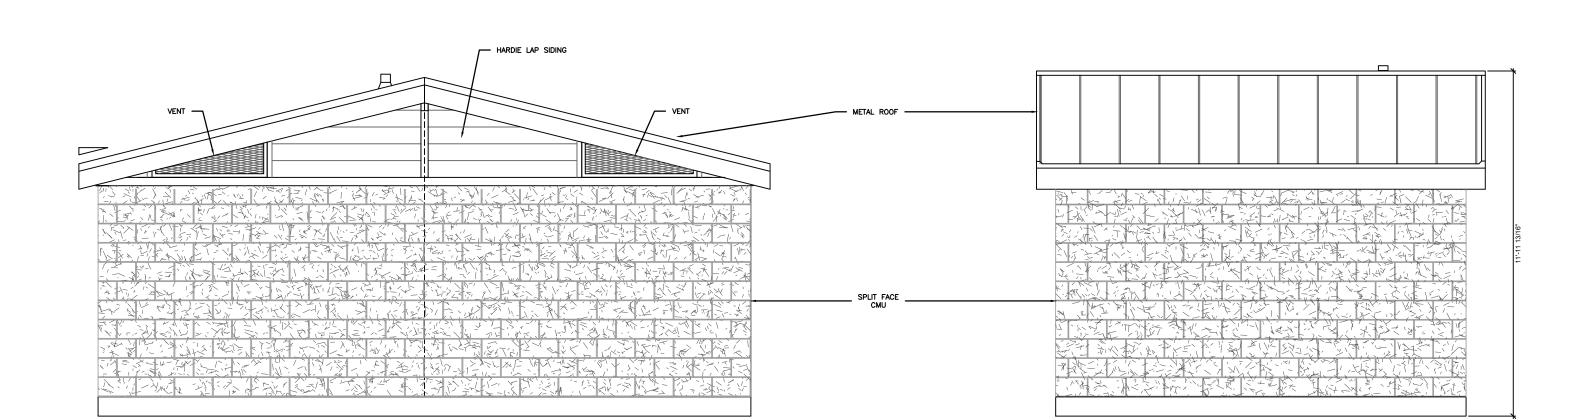

PRE-ENGINEERED RESTROOM - FRONT ELEVATION

PRE-ENGINEERED RESTROOM - RIGHT SIDE ELEVATION

PRE-ENGINEERED RESTROOM BUILDING AND ELEVATIONS




ISSUED FOR BID

10/22/2024

CHECKED DRAWN BY


DETAILS

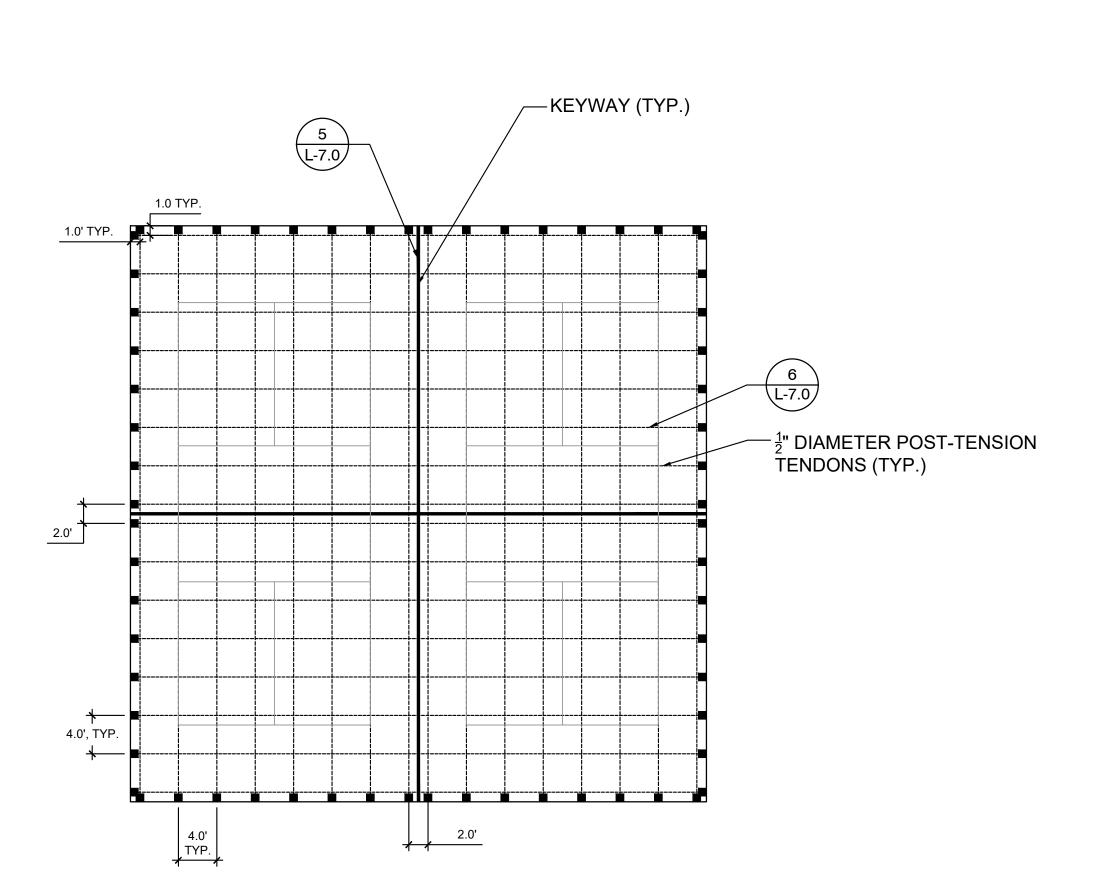


CALL LOUISIANA ONE CALL -1-800-272-3020 LOUISIANA STATE LAW, SECTION R.S.40:1749.15, REQUIRES EXCAVATORS & DEMOLISHERS TO NOTIFY A

THE AREA OR PROVIDE INFORMATION THAT WILL ENABLE AN EXCAVATOR OR DEMOLISHER TO DETERMINE

REGIONAL NOTIFICATION CENTER BY TELEPHONE 48 HOURS IN ADVANCE OF ANY EXCAVATION OR DEMOLITION ACTIVITY. THE OWNERS/OPERATORS OF ANY UNDERGROUND FACILITY MUST THEN MARK

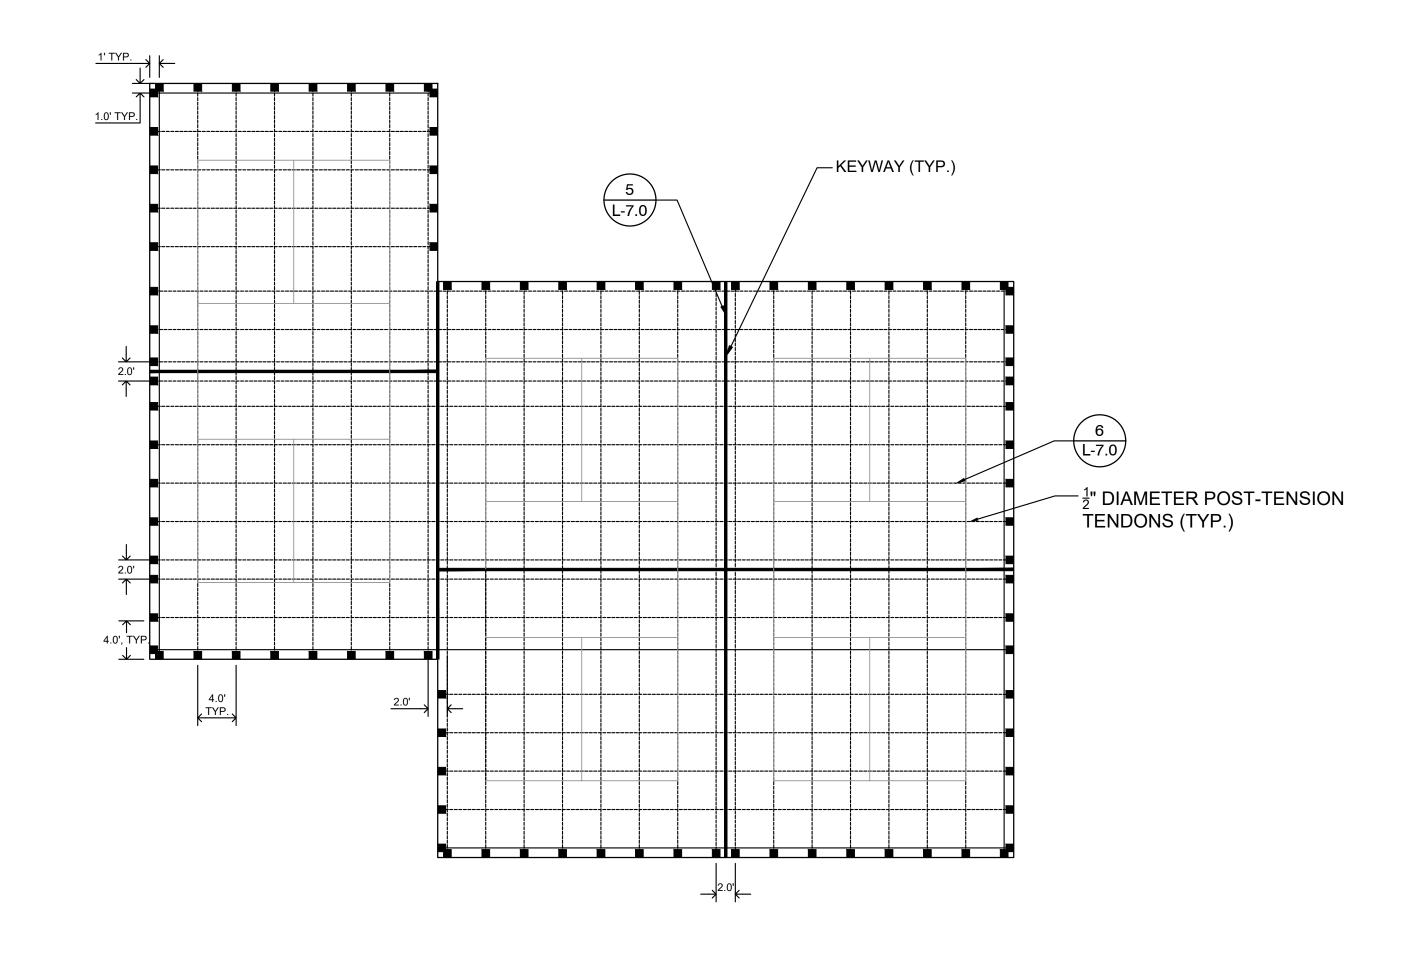

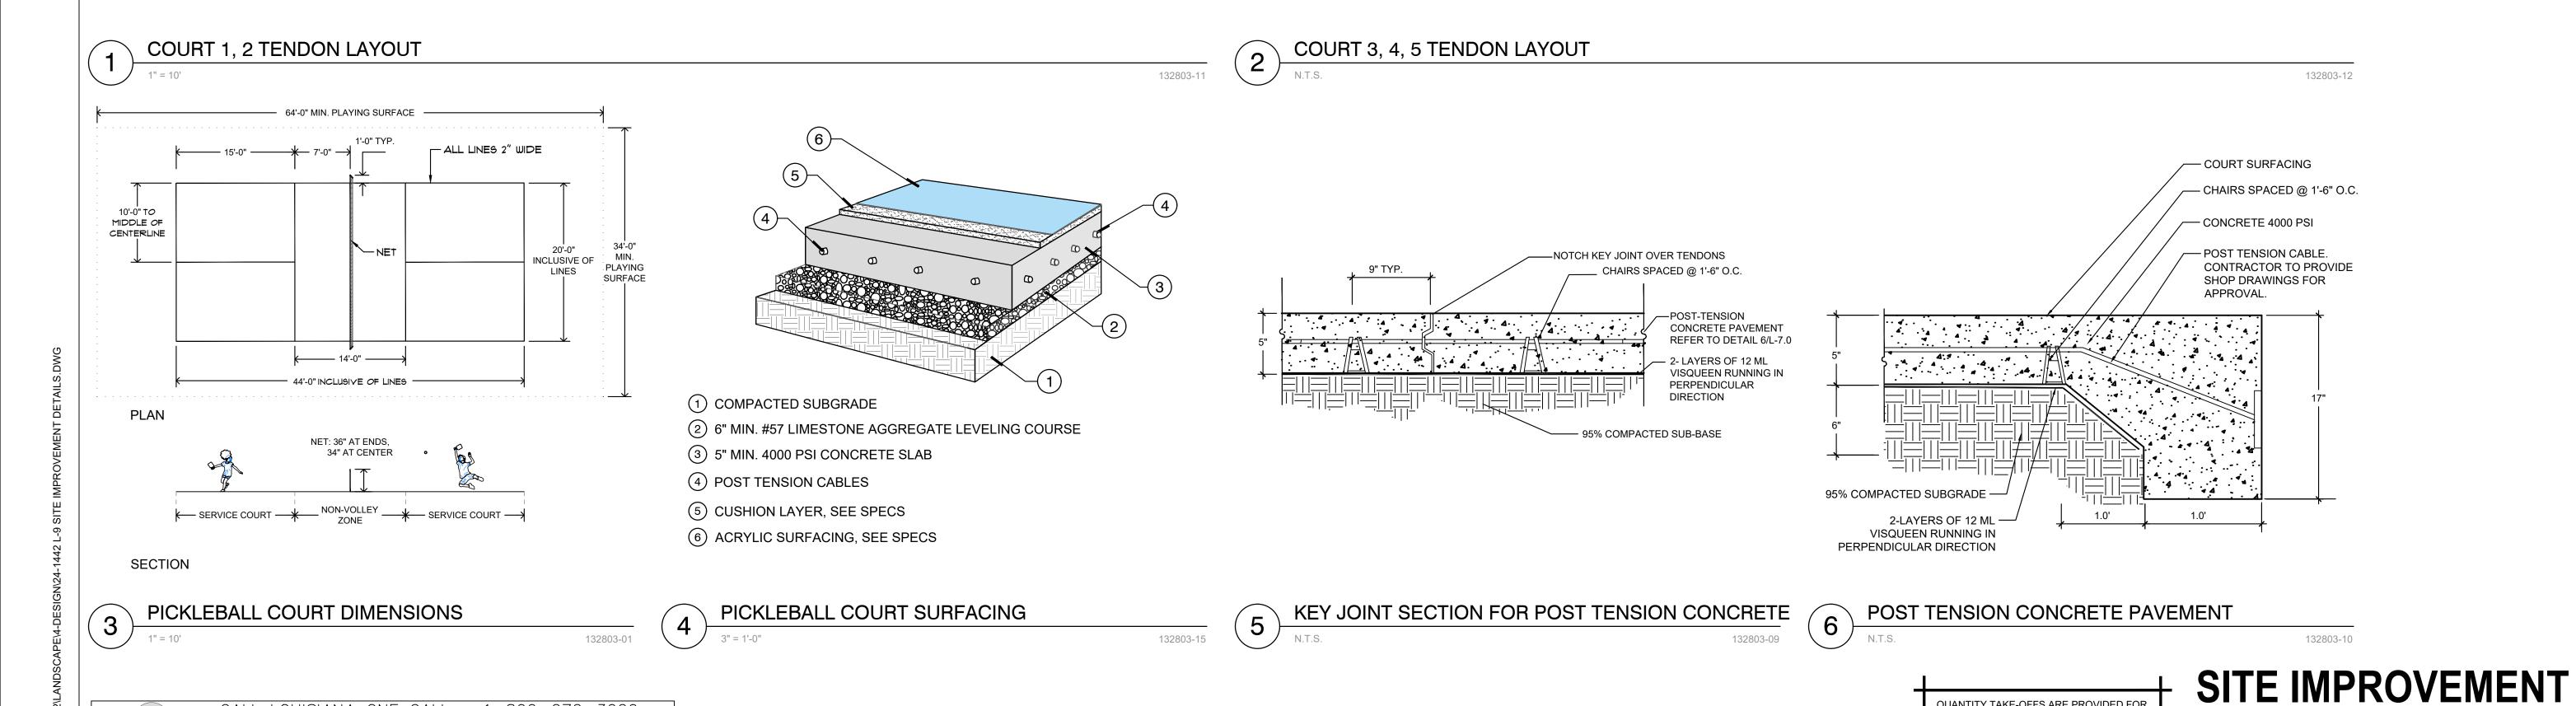

QUANTITY TAKE-OFFS ARE PROVIDED FOR

REFERENCE ONLY. THE CONTRACTOR SHALL

BE RESPONSIBLE FOR VERIFYING ALL QUANTITIES SHOWN ON THESE PLANS

BEFORE PRICING THE WORK.



BID SET -**NOT FOR** CONSTRUCTION

BATON ROUGE, LA 70810 225.751.4490

SO 14318 PRAIF ASCENS

IMPROVEMENT

1

PROJECT NO. ISSUED FOR BID 10/22/2024

MLP

CHECKED DRAWN BY

SHEET

L-7.1

QUANTITY TAKE-OFFS ARE PROVIDED FOR REFERENCE ONLY. THE CONTRACTOR SHALL BE RESPONSIBLE FOR VERIFYING ALL QUANTITIES SHOWN ON THESE PLANS BEFORE PRICING THE WORK.

129323-28

SITE IMPROVEMENT

DETAILS